

City of Beaumont 5600 - 49 Street

Beaumont, Alberta T4X 1A1 Phone: (780) 929-8782 Fax: (780) 929-3300

Email: development@beaumont.ab.ca

Development Permit Notice of Decision

Date of Decision: March 28, 2023

Attn: Perry Dixon/Ed Gooch

EFG Architects Inc. 9834 105 Street

Edmonton, AB., T5K 1A6

Proposed Development: Mixed Use: Retail & Service – General (2 CRUs), Office (1 Unit)

and Residential (3 Units)

Legal Description: Plan 8445ET, Block 1, Lot 8 **Municipal Address:** 5007 50 Street, Beaumont, AB

Land Use District: Main Street
Permit Number: 2022-683
Tax Roll: 000058

Development Permit Status: Approved with conditions

Development Permit Conditions

The development noted above is considered a Permitted Use within the Main Street District and has been **approved** by the Development Authority subject to the conditions listed below. Unless otherwise provided for in this approval, all requirements of the City of Beaumont Land Use Bylaw 944-19 shall be met. Be sure to review all the documentation included with this permit.

- 1. The site shall be developed in accordance with the attached approved plans, issued for Development Permit No. 2023-683, dated March 28, 2023, with the exceptions and conditions as noted herein. Any changes to the attached plans shall require prior written approval by the Development Authority.
- 2. The subject property located at 5007 50th Street (Plan 8445ET, Block 1, Lot 8) shall be consolidated with the property located at 5005 50th Street (Plan 8445ET, Block 1, Lots 6 and 7) through the Land Titles Office, a record of which shall be provided to the City prior to building permit issuance.
- 3. Upon consolidation of Lots, all conditions relating to previously issued Development Permit No. 2019-172 shall remain in effect and compliance shall be required.
- 4. The Applicant shall apply for a Demolition Permit to remove the existing structure on Plan 8445ET, Block 1 Lot 8 prior to any work commencing on the site.
- 5. Landscaping shall be provided as shown on the attached approved plans. Hard landscaping shall be contiguous and seamlessly integrated with the public sidewalk with no grade adjustments.



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- 6. Lighting shall be installed in accordance with the approved attached lighting plan and details, as well as the previously approved lighting plan for Development Permit No. 2019-172, upon consolidation of Lots. Lighting shall be directed downward, and all lighting shall be compliant with International Dark-Sky Association requirements.
- 7. The Applicant shall enter into, and abide by, a Development Agreement with the City of Beaumont, pursuant to Section 650 of the *Municipal Government Act*. The Development Agreement shall be in a form satisfactory to the City and shall require, but is not limited to, the following:
 - a. that the Applicant shall pay a contribution towards the upgrade of the storm water management system; and
 - b. that the Applicant shall construct sidewalks and a boulevard along 50th Street in accordance with the designed setbacks and streetscape plans prepared by ISL Engineering (November 2013), the approved engineering plans, and the General Design Standards, to the satisfaction of the City; and
- 8. Prior to the upgrade of the storm water management system, the Applicant shall be responsible for all costs associated with the pumping out of storm water which may accumulate in the parking lot.
- 9. The Applicant shall provide the development authority with AutoCAD drawings to the satisfaction of the development authority and to be included with the Building Permit Application.
- 10. The owner/applicant shall obtain all Federal, Provincial and local permits as they apply to this project.
- 11. The Site shall be kept clear of all construction garbage and debris; an on-site garbage container/bin shall be required.

Additional Information

1. Prior To Any Work Commencing on the Site:

Construction Permit and Letter of Credit

A Letter of Credit in the amount of 100% of the construction costs for landscaping shall be provided prior to building permit issuance, with such costs to include hard landscaping features such as brick pavers, shale, concrete curbing, sidewalks, patios, paved approaches including culvert and rip rap, fencing and painted lines for parking stalls.

50% of the landscaping security shall be released after planting and the remaining balance to be released once an inspection of the site has demonstrated to the satisfaction of the Development Authority that the landscaping has been well maintained and is in healthy condition two growing seasons after the issuance of the Construction Completion Certification.



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Prior to any construction commencing on the site, a Construction Permit and a Letter of Credit equal to 25% of the construction costs shall be submitted to the City of Beaumont for the following:

- a. any pre-grading of the site including stripping, grubbing, etc.
- b. the cost of work to be undertaken on municipal property, including but not limited to underground servicing and access.

The above noted securities will be returned upon completion, with no deficiencies as confirmed by Engineering and upon completion and receipt of as-built record drawings.

Prior to securing the Letters of Credit for this project, the Applicant shall provide cost estimates for approval by the Manager, Engineering & Environment.

The Letter of Credit shall have an initial term of one (1) year, shall be renewed by the owner 30 days prior to expiry, and shall:

- a. contain an automatic renewal clause; and
- b. allow for partial draws by the City of Beaumont.
- 2. This Development Permit is issued under the City of Beaumont Land Use Bylaw 944-19. It does not exempt you from compliance with any other municipal bylaw or statutory plan applicable to the Proposed Development, any relevant federal or provincial statute or regulation, or any easement, covenant, agreement, or contract affecting the subject lands.
- 3. It is the responsibility of the Applicant to ensure they have reviewed and understand all Instruments registered against the Title of the subject property. This includes all easements, caveats, and restrictive covenants. The City shall not address, nor enforce, any Instruments of which we have no interest in and/or are not a party to.
- 4. Development shall commence within one year from the date of decision noted above. If the development does not commence within this time frame, a new development permit shall be required.
- 5. The Owner shall be responsible for reimbursement of all engineering and/or legal costs relating to this project that may be incurred by the City of Beaumont.
- 6. The Applicant shall abandon existing services at main, with confirmation sign-offs being a requirement for future Demolition Permit Application. Abandonment work shall be completed under the supervision of the City of Beaumont, Public Works, with all associated costs to the City being reimbursed by the Applicant.
- 7. This Notice of Decision is NOT a building permit. Work or construction shall not commence until an applicable Building Permit has been issued under the Alberta Safety Codes Act and any other applicable bylaws or regulations. Three detailed, engineer approved, drawing sets of building floor plan, including Electrical, Plumbing, Gas and Mechanical schedules, shall be included with building permit application submission. **All Schedules shall be included.**



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- 8. The Applicant shall contact all franchise utilities to arrange for any service connections that are required. Where City utilities and services are interfered with, or for construction on municipal property, the Applicant shall be responsible for the cost of relocation/repair of these municipal services.
- 9. The water meter(s) for this project shall be purchased from the City of Beaumont. For each meter to be installed a "Water Meter Permit Request" must be completed electronically and submitted to waterandwastewater@beaumont.ab.ca. This application must be submitted thirty (30) days prior to occupancy. Size, type, and number of meters per building must be approved by the City of Beaumont.
- 10. The City of Beaumont subcontracts permitting services for Plumbing, Electrical and Gas disciplines to Superior Safety Codes.
- 11. The City of Beaumont Fire Department shall be provided with one (1) elevator key, to be used in case of an emergency.
- 12. The Applicant shall purchase a key box from the City Hall Office to ensure all building units are accessible in case of an emergency.
- 13. Contact Alberta One Call at 1-800-242-3447 to locate underground services prior to construction, if applicable.
- 14. Sanitary and sewer connections for this development shall be made within the site boundaries unless otherwise approved by the Manager, Engineering & Environment in accordance with the General Design Standards of the City of Beaumont.
- 15. A storm drainage plan shall be prepared for approval by the Manager, Engineering & Environment. The storm water system should be designed to control storm water flow to a level that would be expected from a residential development of equivalent size.
- 16. The water meter(s) for this project shall be purchased from the City of Beaumont. For each meter to be installed a "Water Meter Permit Request" must be completed electronically and submitted to waterandwastewater@beaumont.ab.ca. This application must be submitted thirty (30) days prior to occupancy. Size, type, and number of meters per building must be approved by the City of Beaumont.
- 17. Separate sign permit applications will be required for any on-site signage.

Permit Notification Information

In accordance with the City of Beaumont Land Use Bylaw 944-19, notice regarding this Development Permit has been published on our website, only.



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Appeal Information

Permitted Uses may not be appealed unless the provisions of the Land Use Bylaw were relaxed, varied, or misinterpreted. If you have reason to appeal this Development Permit or any of the above conditions on these grounds, you may submit an appeal to the Secretary of the Subdivision Development and Appeal Board (SDAB) within 21 days of the date the decision was made, noted above.


To file an appeal or to get information on the appeal process you must contact the Secretary of the SDAB directly at 780-929-8782 or at legislative@beaumont.ab.ca. Appeals must be filed no later than 4:30 p.m. on the date indicated above.

For more information regarding this Development Permit, its conditions, or the Land Use Bylaw, contact the Development Authority who made the decision on this permit:



Patricia Lauzé Development Officer 780-235-8786 Patricia.Lauze@Beaumont.ab.ca

cc: Curtis Doblanko, Director, Finance
Kendra Raymond, Director, Planning & Development
Jennifer Niesink, Director, Economic Development
Jay Melvin, Director, Protective Services & Fire Chief
Punam Grewal, Manager, Engineering & Environment
Joannes Wong, Manager, Long Range Planning
Shawn Hipkiss, Manager, Current Planning
Aleshia Ingram, Senior Development Planner
Charles Conroy, Development & Engineering Coordinator
Ellen Feron, Operations Facility Administrative Assistant
Troy Birtles, Accurate Assessment
Kate Alexander, Leduc Public Health

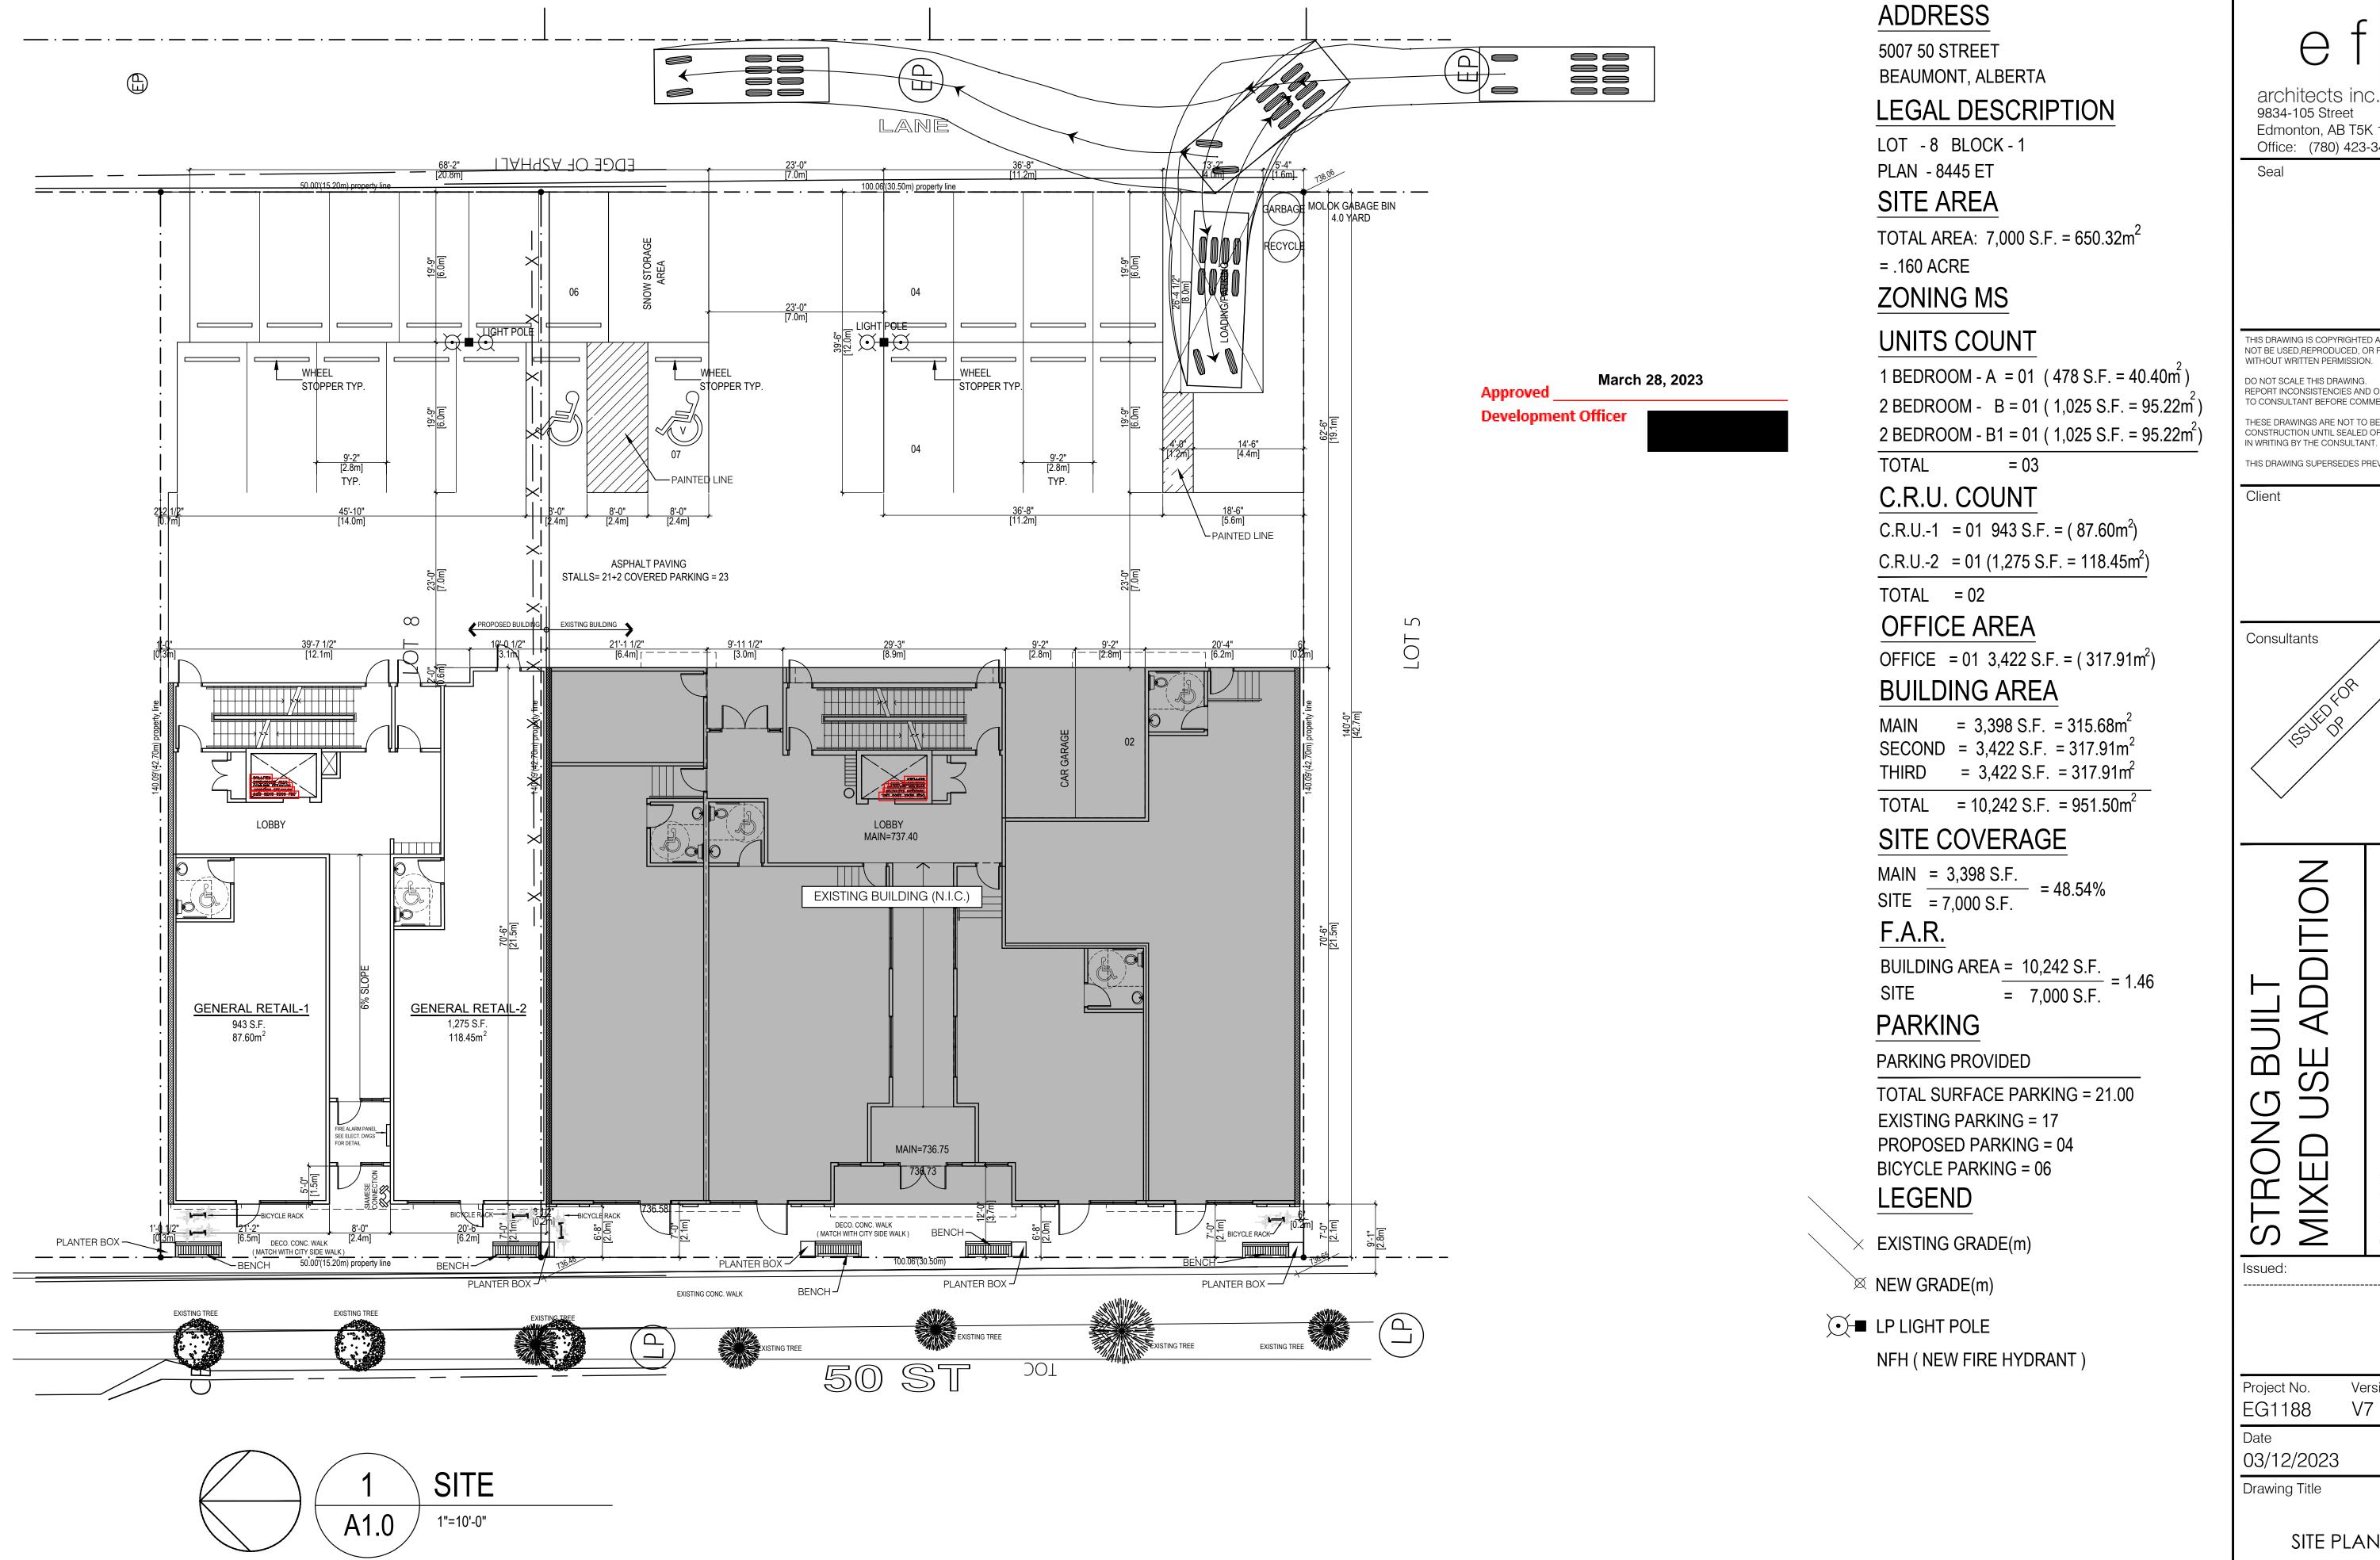


architects inc 9834-105 Street

Edmonton, AB T5K 1A6 Office: (780) 423-3424

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ADDITIO BUILT

Version:

EG1188 V7

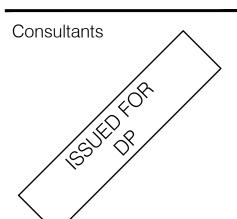
03/12/2023


Drawing Title

SITE PLAN

Drawing No.

A1.0

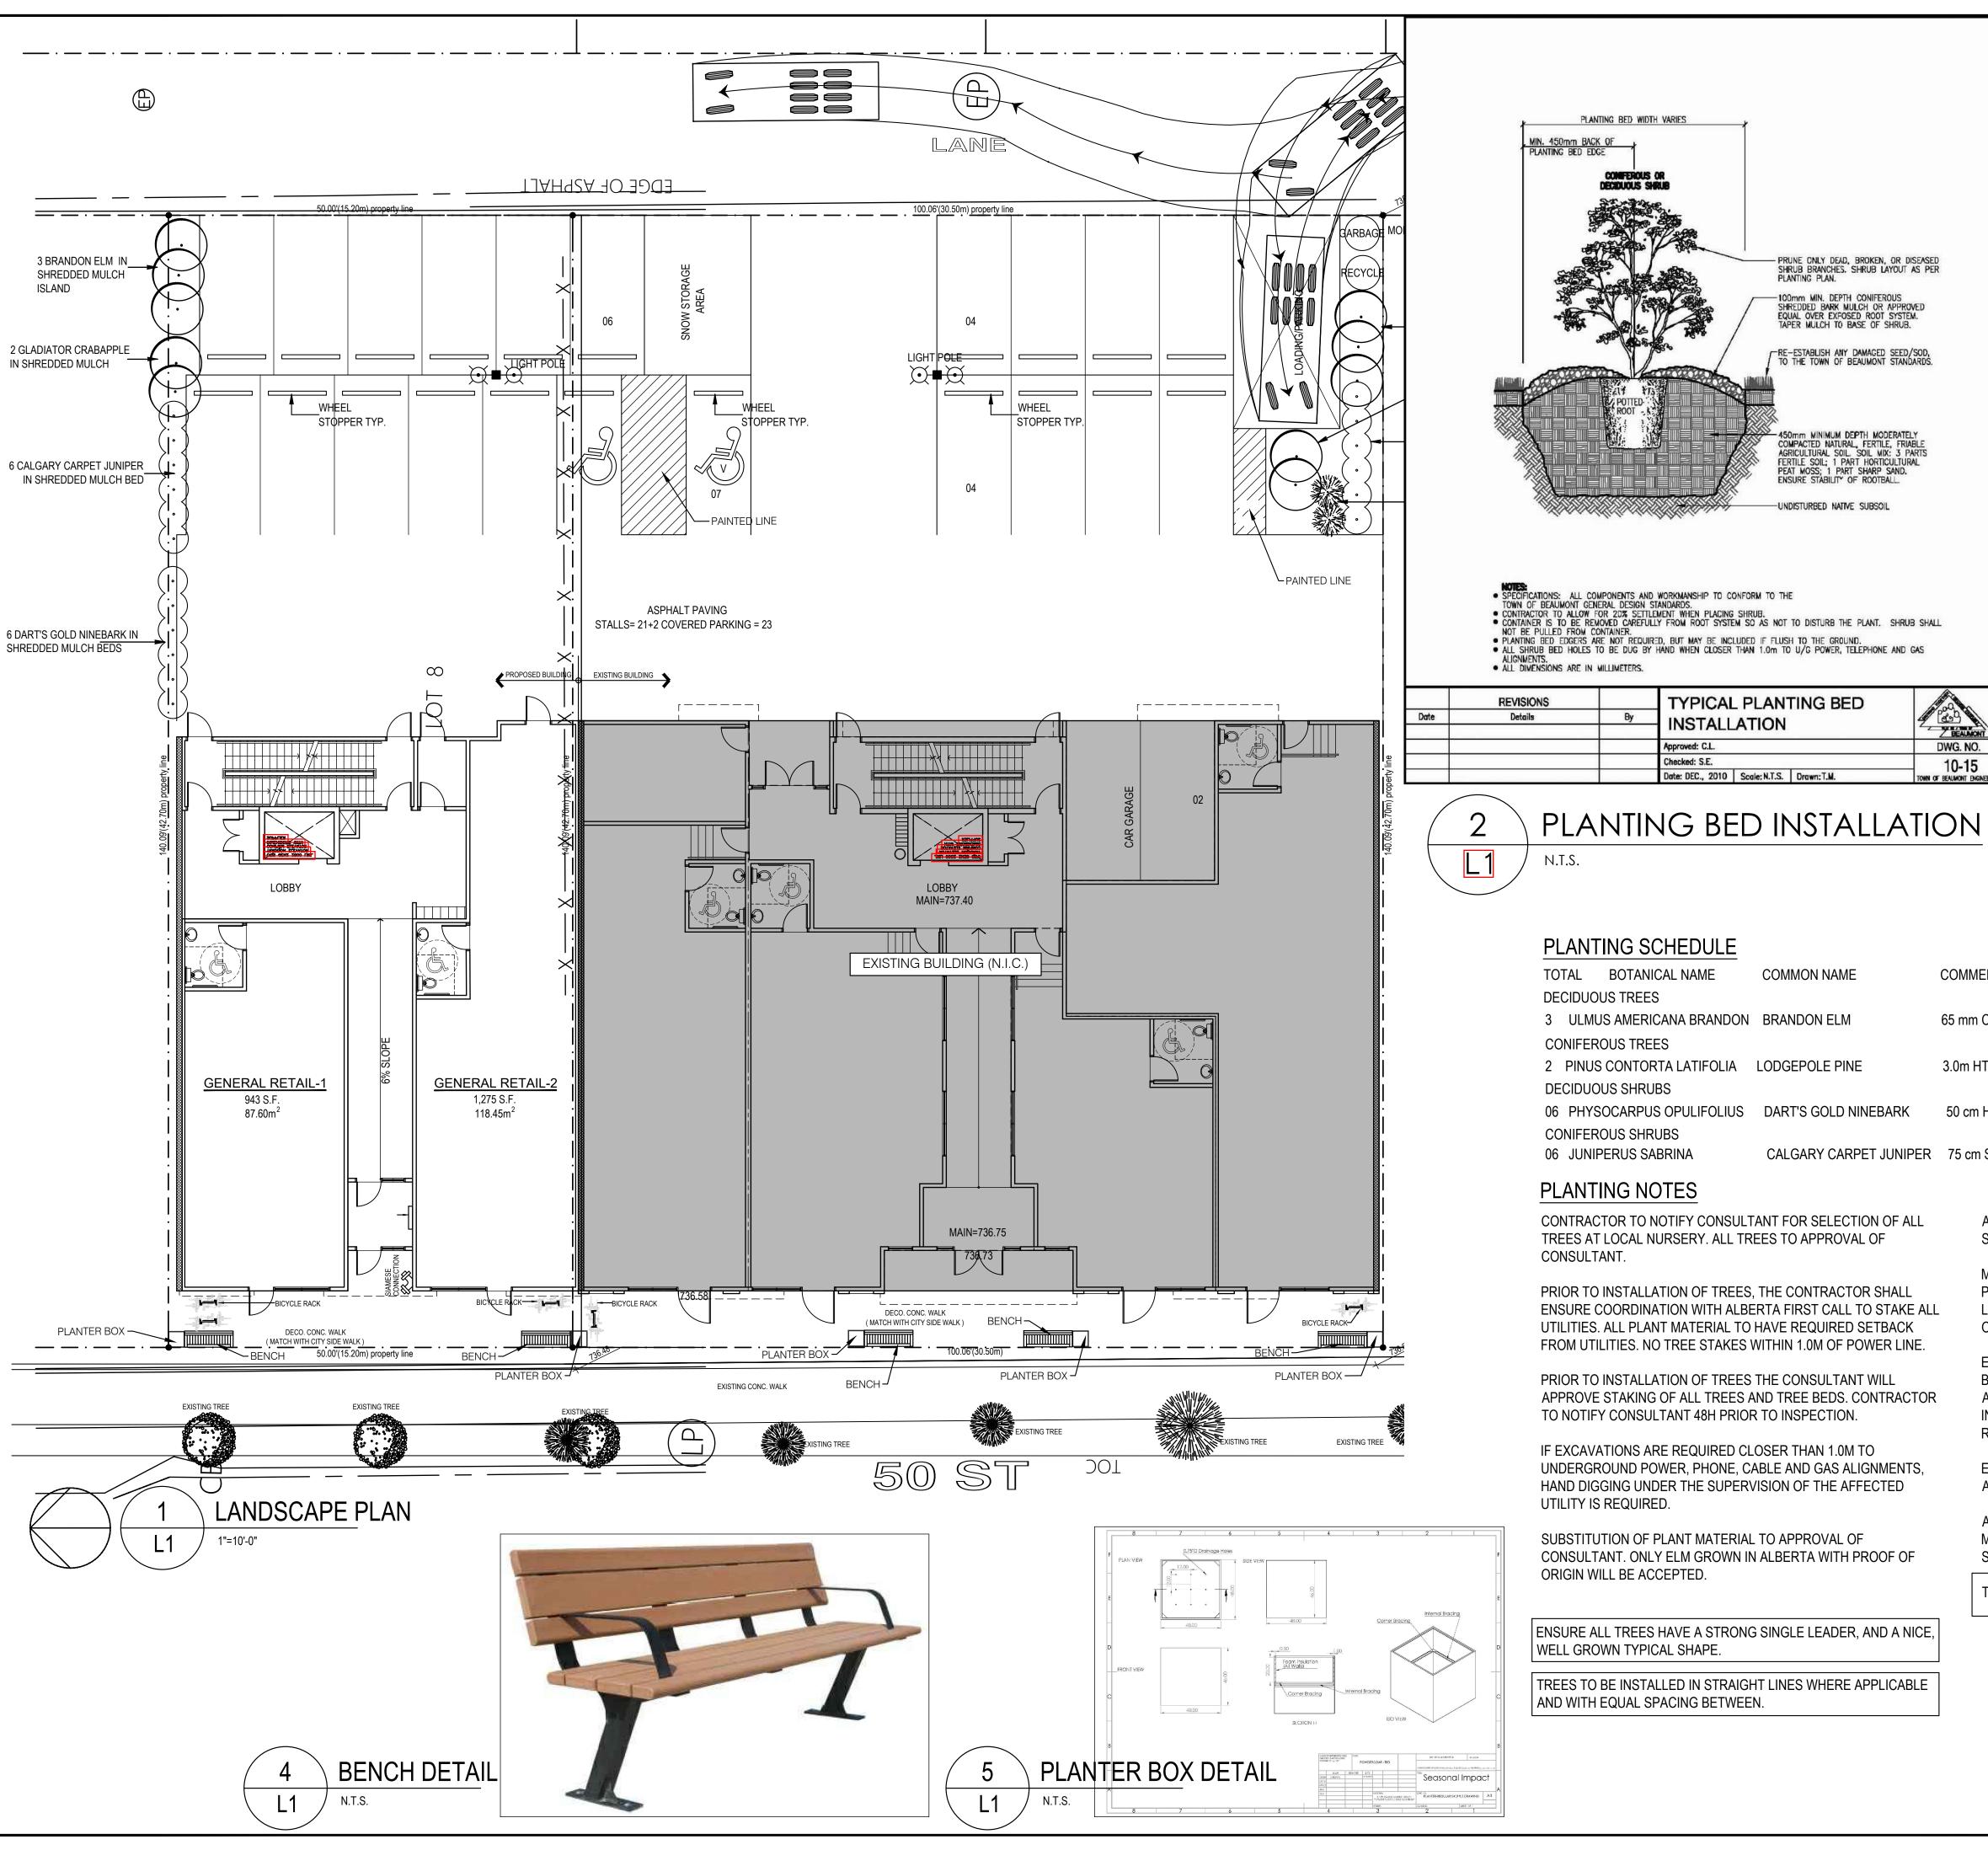

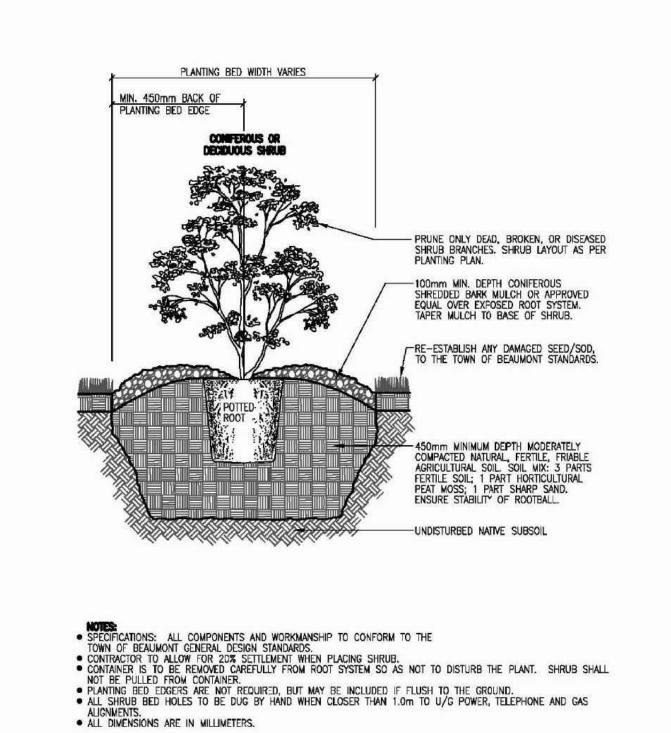

-PRUNE ONLY DEAD, BROKEN OR DISEASED TREE LIMBS. -FLUORESCENT ORANGE FLAGGING ON ALL GUY WIRES. - GALVANIZED GUY WIRE No. 10 MIN. — MINIMUM OF 2 STAKES PER TREE. LARGE TREES TO HAVE 3-4 STAKES. METAL T-BAR (2450mm) EXTENDED 900mm INTO UNDISTURBED SOIL. METAL T-BARS TO REMAIN FOR TWO GROWING SEASON. TOP 300mm OF TREE STAKES ARE PAINTED TO MATCH ANNUAL COLOUR CODES TO IDENTIFY YEAR OF PLANTING. **OUTWARDS** RE-ESTABLISH ANY DAMAGED SEED/SOD, TO THE TOWN OF BEAUMONT STANDARDS. - 100mm MIN. DEPTH OF CONIFEROUS SHREDDED BARK MULCH OR APPROVED EQUAL OVER EXPOSED ROOTBALL. TAPE MULCH TO BASE OF TREE. MULCH TO EDGE OF DISTURBED AREA. MCDERATELY COMPACTED NATURAL FERTILE, FRIABLE AGRICULTURAL SOIL. ENSURE STABILITY OF ROOTBALL. -FOLD 1/3 WIRE BASKET AND BURLAP FROM TOP OF ROOTBALL. POSITION TOP OF ROOTBALL 50mm MAXIMUM BELOW FINISH GRADE. BURLAP TO BE TREATED NATURAL FIBRE. -UNDISTURBED NATIVE SOIL SPECIFICATIONS: ALL COMPONENTS AND WORKMANSHIP TO CONFORM TO THE TOWN OF BEAUMONT GENERAL DESIGN STANDARDS.
 SATURATE SAUCER WITH WATER IMMEDIATELY AFTER PLANTING.
 POSITION TREE STAKES INTO DIRECTION OF PREVAILING WINDS IF MINIMUM LITLITY SETBACKS PERMIT.

ALL TREE STAKES TO HAVE A MINIMUM 1.0m CLEARANCE FROM ALL U/G POWER, TELEPHONE AND GAS ALIGNMENTS.

ALL ROOTBALL HOLES TO BE DUG BY HAND WHEN CLOSER THAN 1.0m TO U/G POWER, TELEPHONE AND GAS ALIGNMENTS.

ALL DIMENSIONS ARE IN MILLIMETERS. TYPICAL TREE INSTALLATION DWG. NO. pproved: C.L. Checked: S.E. 10-18 TOWN OF BEAUMONT ENGINEER Date: DEC., 2010 | Scale: N.T.S. | Drawn: T.M.

BEAUMONT, ALBERTA

LOT -8 BLOCK-1

PLAN - 8445 ET SITE AREA

= .160 ACRE ZONING MS

UNITS COUNT

TOTAL = 03 C.R.U. COUNT

TOTAL = 02

OFFICE AREA

LEGAL DESCRIPTION

TOTAL AREA: 7,000 S.F. = 650.32m²

1 BEDROOM - A = 01 (478 S.F. = 40.40m^2)

2 BEDROOM - B = 01 (1,025 S.F. = 95.22m²) 2 BEDROOM - B1 = 01 (1,025 S.F. = 95.22m²)

C.R.U.-1 = 01 943 S.F. = (87.60m²) C.R.U.-2 = 01 (1.275 S.F. = 118.45m²)

OFFICE = 01 $3,422 \text{ S.F.} = (317.91 \text{ m}^2)$

Details TREE INSTALLATION



TOTAL BOTANICAL NAME COMMON NAME COMMENTS

TYPICAL PLANTING BED

Date: DEC., 2010 | Scale: N.T.S. | Drawn: T.M.

INSTALLATION

3 ULMUS AMERICANA BRANDON BRANDON ELM

CONIFEROUS TREES

2 PINUS CONTORTA LATIFOLIA LODGEPOLE PINE DECIDUOUS SHRUBS

06 PHYSOCARPUS OPULIFOLIUS DART'S GOLD NINEBARK

CONIFEROUS SHRUBS

06 JUNIPERUS SABRINA

CONTRACTOR TO NOTIFY CONSULTANT FOR SELECTION OF ALL TREES AT LOCAL NURSERY. ALL TREES TO APPROVAL OF CONSULTANT.

IF EXCAVATIONS ARE REQUIRED CLOSER THAN 1.0M TO UNDERGROUND POWER, PHONE, CABLE AND GAS ALIGNMENTS, HAND DIGGING UNDER THE SUPERVISION OF THE AFFECTED UTILITY IS REQUIRED.

SUBSTITUTION OF PLANT MATERIAL TO APPROVAL OF CONSULTANT. ONLY ELM GROWN IN ALBERTA WITH PROOF OF

ENSURE ALL TREES HAVE A STRONG SINGLE LEADER, AND A NICE, WELL GROWN TYPICAL SHAPE.

DWG. NO.

10-15

65 mm CAL. MIN. 4.0m HT. MIN. B & B

3.0m HT. MIN. B & B

50 cm HT. MIN. 5 MAJOR BASAL BRANCHES 2 GAL. POT

CALGARY CARPET JUNIPER 75 cm SPREAD. MIN. 5 MAJOR BASAL BRANCHES 5 GAL. POT

PLANTING NOTES

PRIOR TO INSTALLATION OF TREES, THE CONTRACTOR SHALL ENSURE COORDINATION WITH ALBERTA FIRST CALL TO STAKE ALL UTILITIES. ALL PLANT MATERIAL TO HAVE REQUIRED SETBACK FROM UTILITIES. NO TREE STAKES WITHIN 1.0M OF POWER LINE.

PRIOR TO INSTALLATION OF TREES THE CONSULTANT WILL APPROVE STAKING OF ALL TREES AND TREE BEDS. CONTRACTOR TO NOTIFY CONSULTANT 48H PRIOR TO INSPECTION.

ORIGIN WILL BE ACCEPTED.

TREES TO BE INSTALLED IN STRAIGHT LINES WHERE APPLICABLE AND WITH EQUAL SPACING BETWEEN

ALL SHRUB BEDS 450MM DEPTH SOIL MIX MINIMUM. SHRUB SETBACK SHALL BE 450MM MIN. FROM EDGE OF SHRUB BED.

USE 75MM DEPTH SHREDDED MULCH FOR ALL TREE PLANTING AND PLANTING BEDS UNLESS OTHERWISE NOTED. NO LANDSCAPE FABRIC REQUIRED UNDER SHREDDED MULCH UNLESS OTHERWISE NOTED.

EDGING: USE PERMALOC PERMASTRIP ALUMINUM EDGING BETWEEN GRASS AND SHRUB AND PERENNIAL BEDS, AND GRASS AND ROCK MULCH. EDGING INSTALLED AS PER MANUFACTURERS INSTRUCTIONS. EDGING TO BE STRAIGHT. NO EDGING IS REQUIRED FOR TREE BEDS AND SINGLE TREES IN GRASS AREAS.

ENSURE CONTROL OF NOXIOUS WEEDS FOR ALL LANDSCAPED AREAS.

ALL LANDSCAPE CONSTRUCTION AND MAINTENANCE (ONE YEAR MINIMUM) TO BE COMPLETED BUT NOT LIMITED TO MINIMUM STANDARDS OF TOWN OF BEAUMONT DESIGN STANDARDS.

TOTAL LANDSCAPE AREA: 884SQM

March 28, 2023 Development Officer

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architects inc

Edmonton, AB T5K 1A6

Office: (780) 423-3424

9834-105 Street

Seal

IN WRITING BY THE CONSULTANT. THIS DRAWING SUPERSEDES PREVIOUS ISSUES.

Client

Consultants

B


Project Address: 5007 50 STREET BEAUMONT, ALBE MXE MXE Issued:


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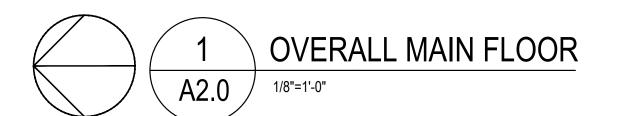
03/12/2023 Drawing Title


> LANDSCAPE PLAN

Drawing No.




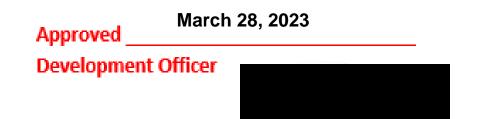

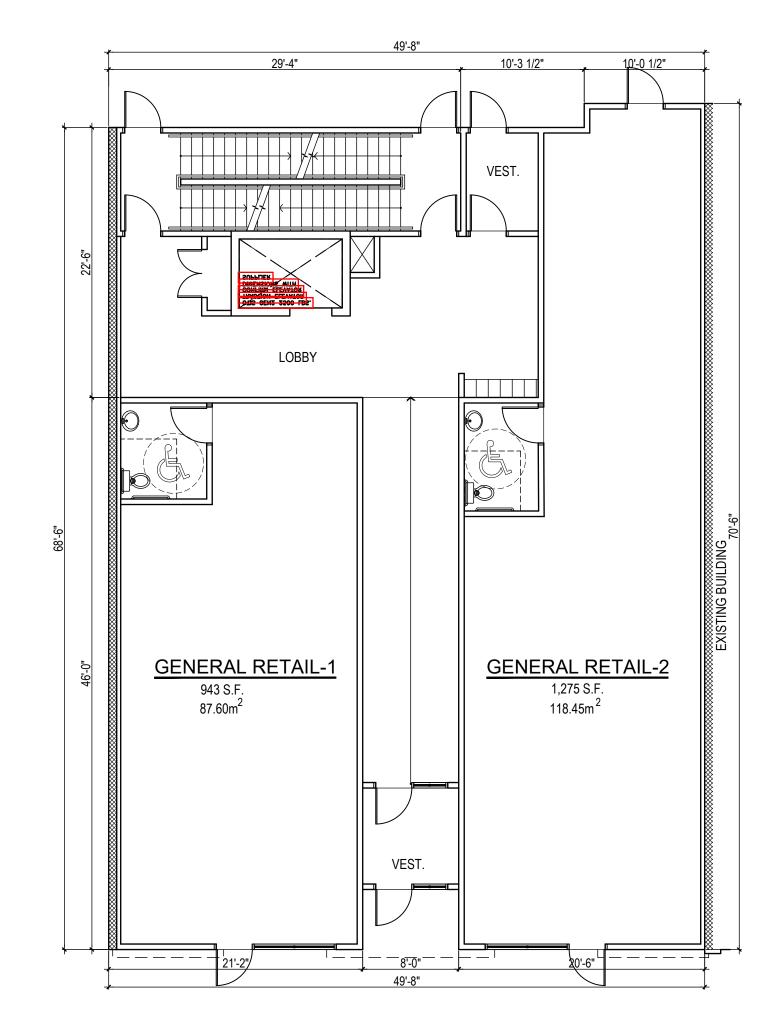

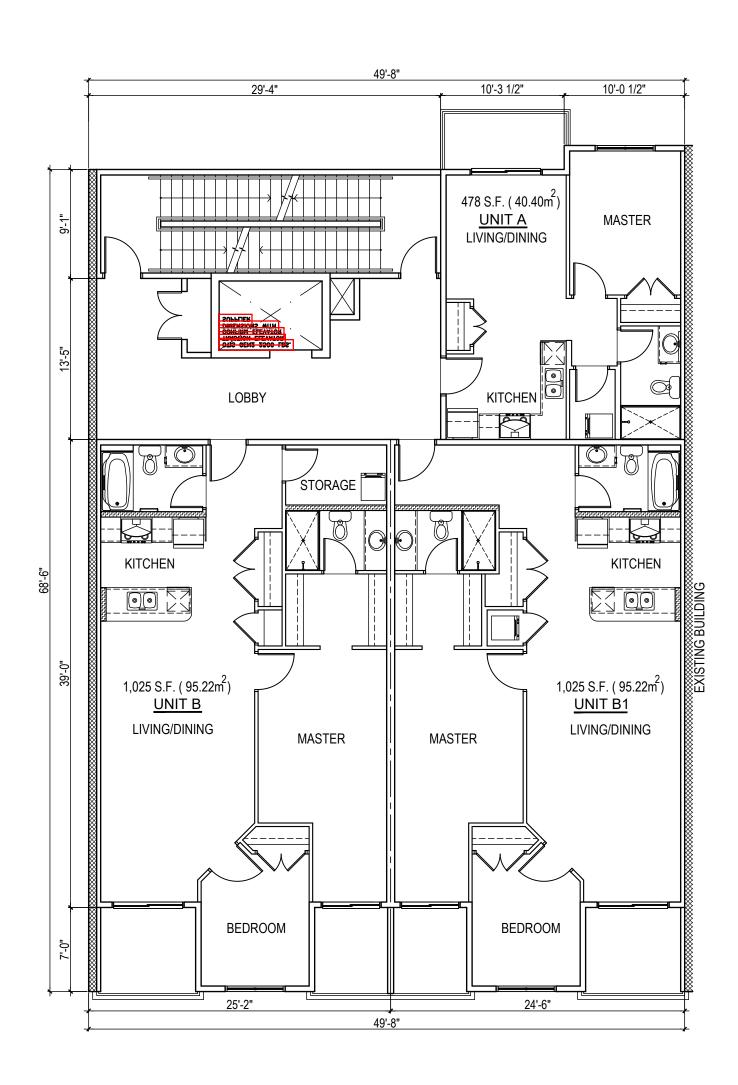



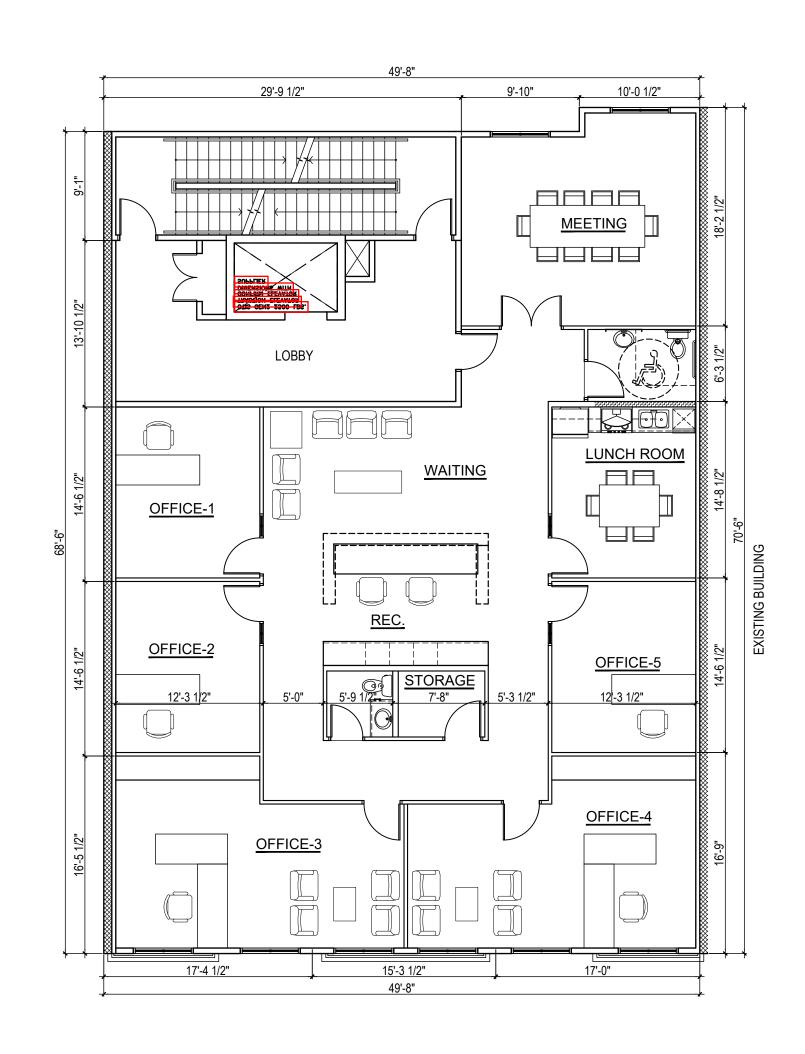



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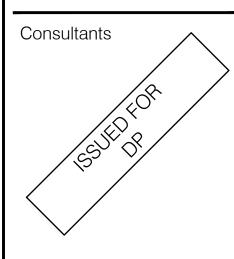
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STRONG BUILT
MIXED USE ADDITION

Project No. Version: V7

Project Address: 5007 50 STREET BEAUMONT, ALBERTA

Date 02/15/2023

02/10/20

Drawing Title

OVERALL MAIN/
SECOND/THIRD

FLOOR


Drawing No.

A2.0



EAST ELEVATION

A4.0

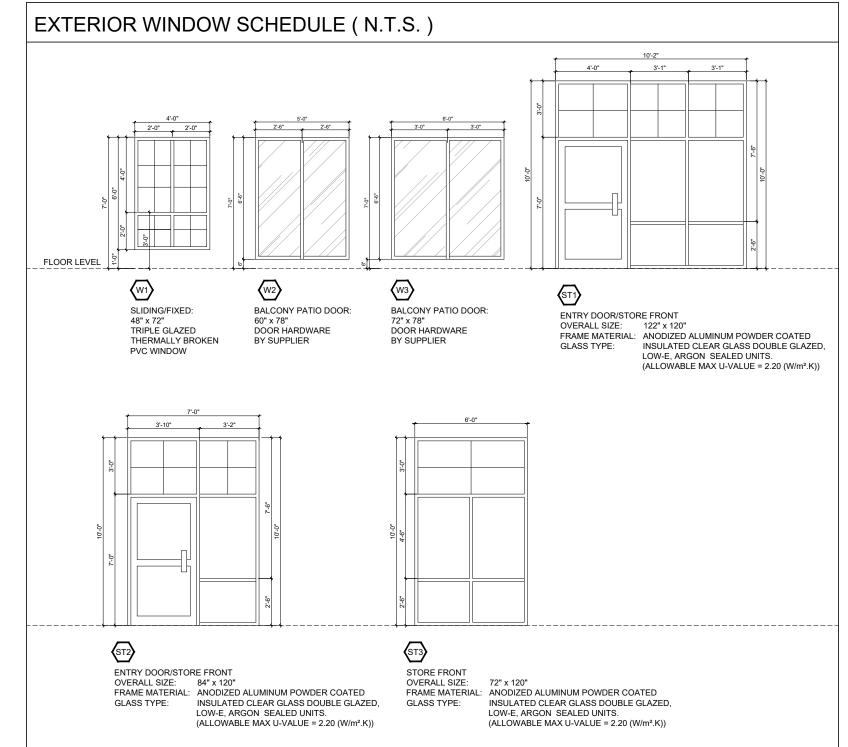

EXTERIOR FINISH SCHEDULE

SENERGY STUCCO -S1-309 BURME SENERGY STUCCO -S2-3104 WALDER WINDOW TRIM - S3- 3104 WALDER

BRICK - S4 IXL RED BRICK BRICK - S5 IXL SEA GRAY BRICK

NOTES: METAL TRIM, RAILING & RAINGOODS - BLACK PREFINISHED ALUMINUM

METAL CANOPY - BLACK ALL WINDOWS TO BE BLACK ALUMINIUM TO MATCH STORE FRONTS METAL EXIT DOORS- PAINT AS PER OWNERS SELECTION



GOOSENECK LIGHT A4.0 /

9834-105 Street Edmonton, AB T5K 1A6

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ADDITIO STRONG BUILT MIXED Issued:

Project Address: 5007 50 STREET BEAUMONT, ALBERTA

Project No. Version: EG1188


Date 03/22/2023

Drawing Title

ELEVATIONS

Drawing No.

A4.0

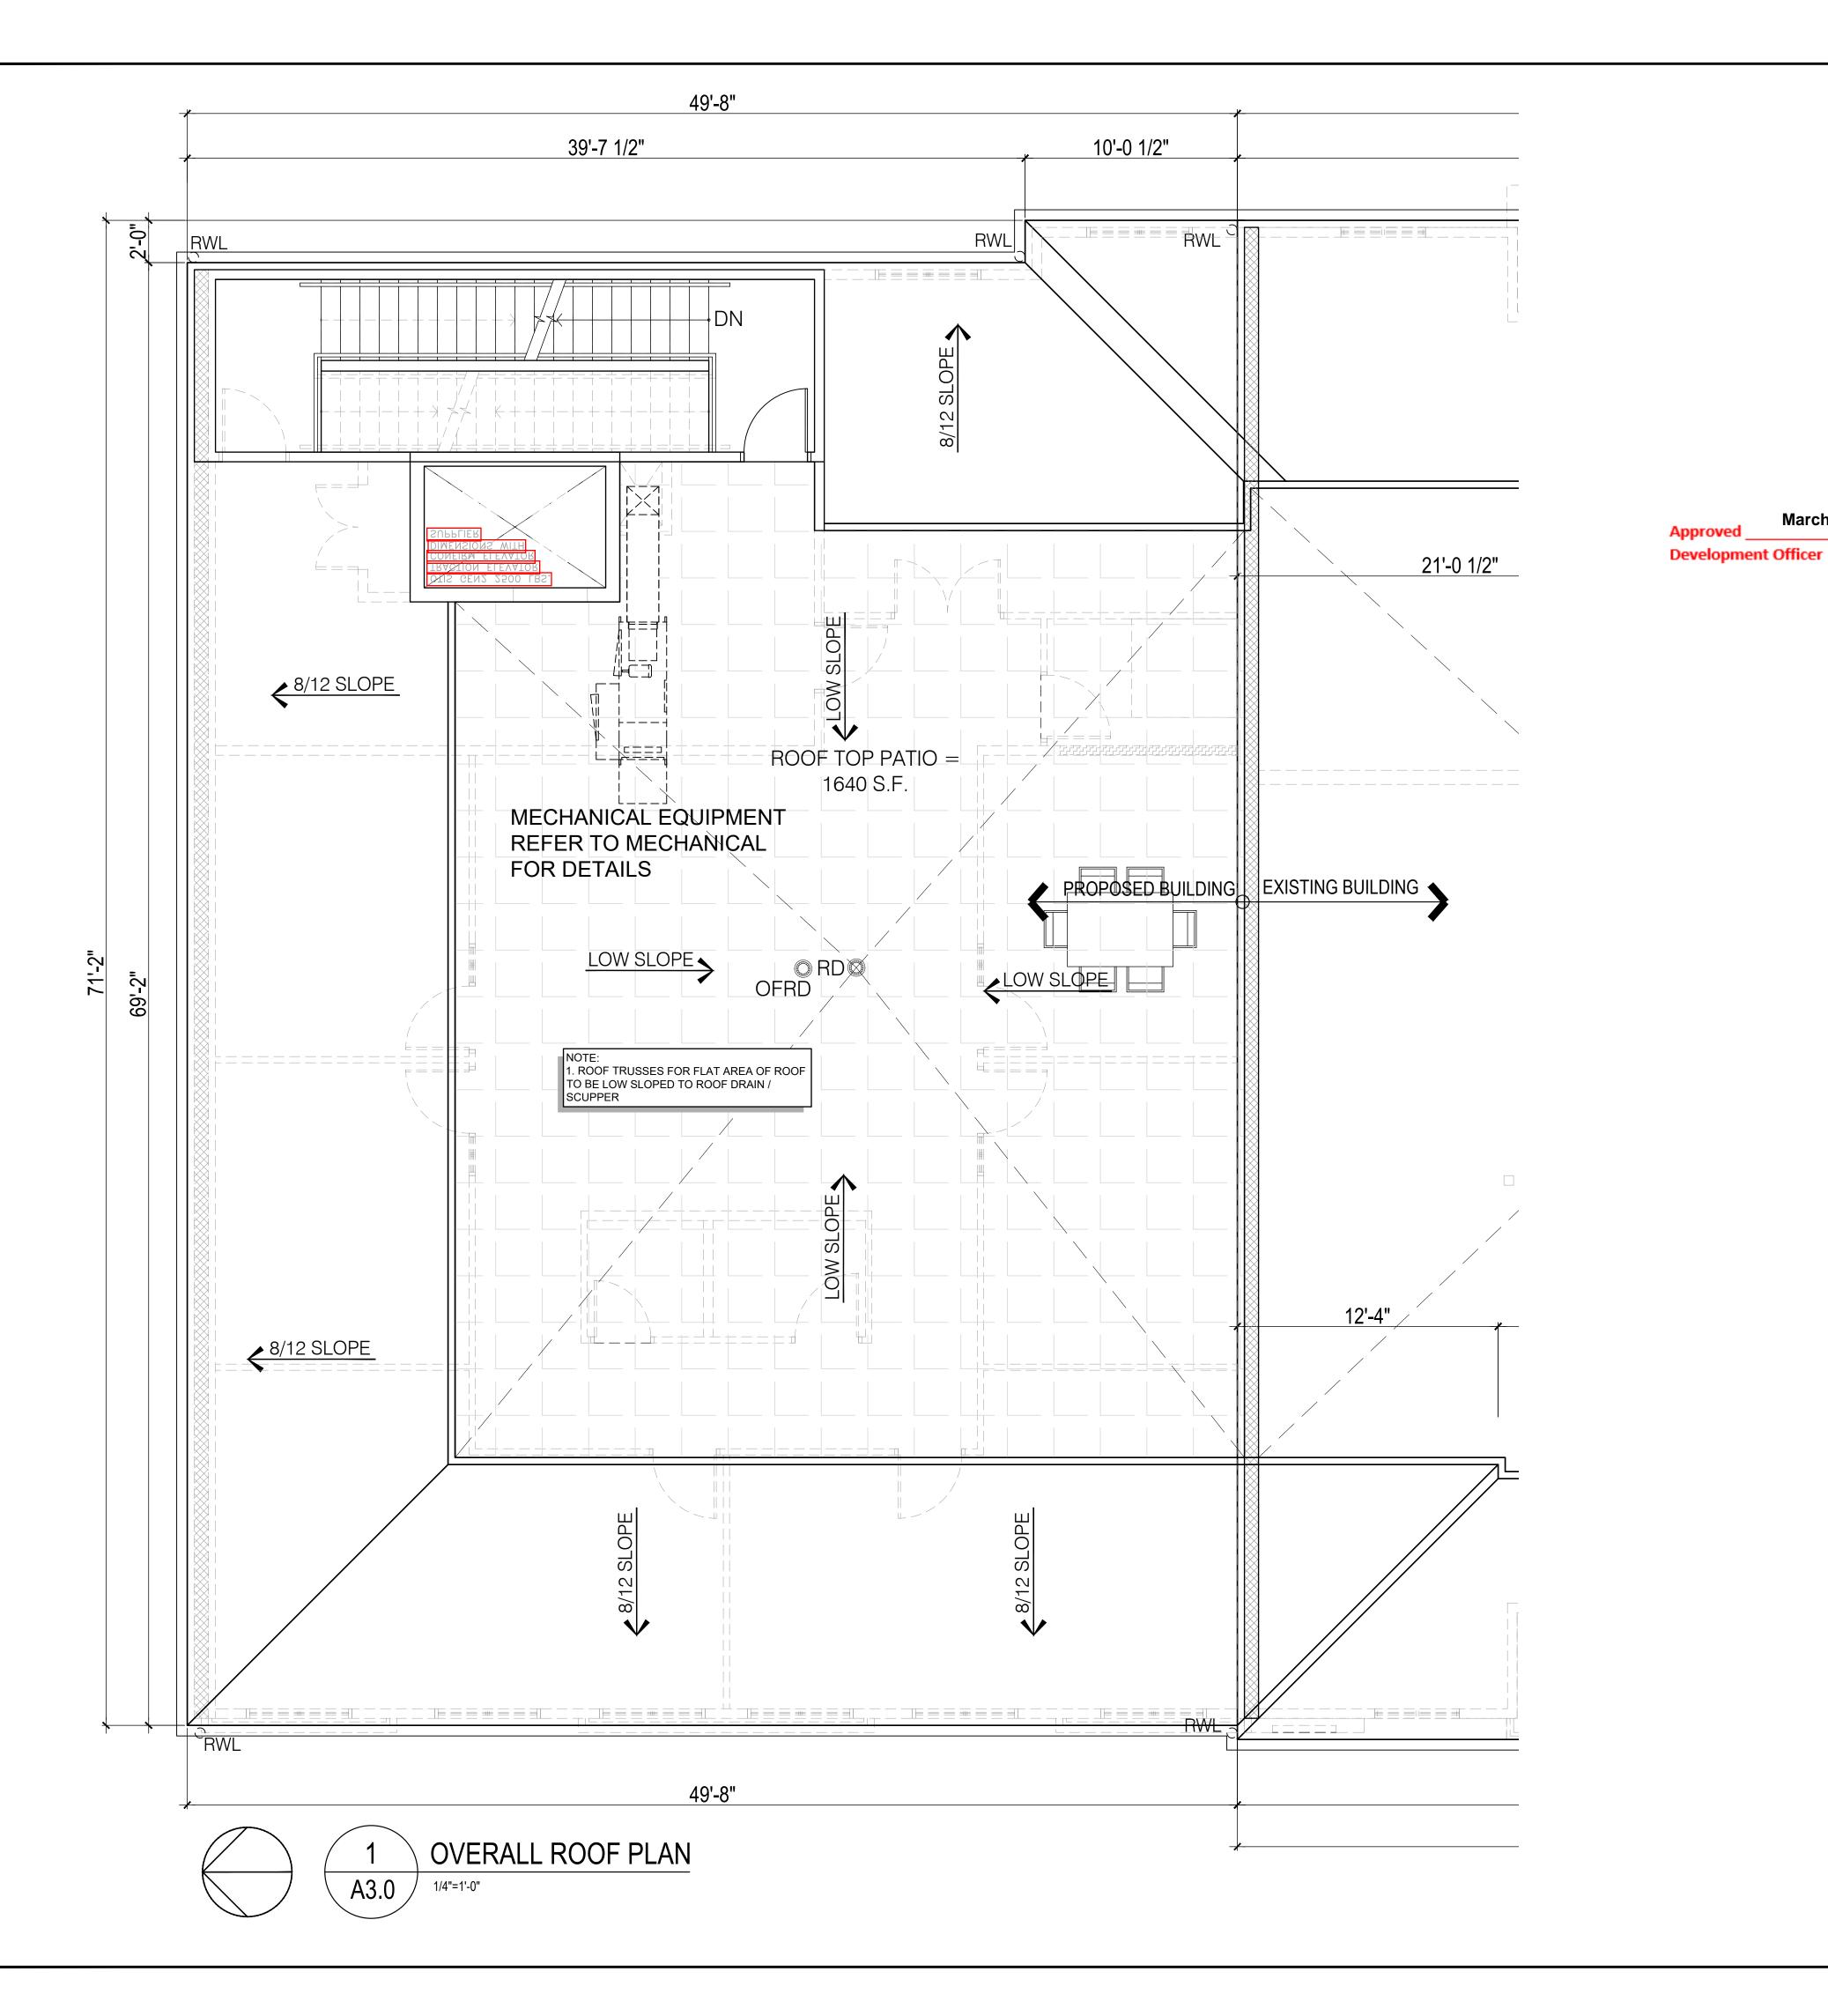

- ASPHALT SHINGLES

- PRE-ENGINEERED WOOD TRUSSES - R40 BATT INSULATION

LOW SLOPED ROOF - (SPRINKLER) FIRE RATING: 1HR - NBC(AE) 2019 (D-2.3.12.)
- 2 PLY SBS WATERPROOFING MEMBRANE

- FULLY ADHERED A/V BARRIER - EXTERIOR GRADE SHEATHING (AS PER STRUCTURAL) - PRE-ENGINEERED WOOD TRUSSES - R40 BATT INSULATION

March 28, 2023

- 6mil POLY VAPOUR BARRIER

ON 3/4" PLYWOOD SECURE IN PLACE W/ SCREWS OR LATCHES.

S3. SADDLES: CONSTRUCT SADDLES MINIMUM SLOPE 1/12 TO DRAIN ROOF AREAS WITH LEVEL VALLEYS. FLASH SADDLES UNDER SHINGLES WITH ICE AND WATERSHIELD MEMBRANE.

S2. DRAINAGE SLOPES SHOWN ARE APPROXIMATE. ROOFING SUPPLIERS TO PROVIDE EXACT ROOF SLOPES

RS4. ALL DRAINAGE PIPES IN CEILING TO BE CAST IRON

RS5. ALL FIRE RATED ROOFS TO BE SPRINKLERED TO NFPA 13

BE EXTENDED TO U/S OF FLOOR / ROOF DECKING (UNLESS OTHERWISE NOTED)

7. COORDINATE WITH STRUCTURAL, MECHANICAL AND ELECTRICAL CONTRACTORS/ENGINEERS FOR ROOF OPENINGS

B. PROVIDE AND INSTALL 14" HIGH PRE-MANUFACTURED INSULATED ROOF CURB BELOW ALL ROOF TOP UNITS ON ALL FOUR SIDES. INSTALL R28 MIN. RIGID EXTRUDED POLYSTYRENE INSULATION C/W VAPOUR BARRIER BELOW ALL ROOF TOP UNITS AND WITHIN ROOF CURB.

ROOF DRAIN / OVERFLOW ROOF DRAIN

RAIN WATER LEADERS

ROOF SCHEDULE

TYPICAL SLOPED ROOF - (SPRINKLER) FIRE RATING: 1HR - NBC(AE) 2019 (D-2.3.12.)

- EXTERIOR GRADE SHEATHING (AS PER STRUCTURAL)

- 6mil POLY VAPOUR BARRIER - 5/8" TYPE X GYPSUM CEILING BOARD - 5/8" TYPE X GYPSUM CEILING BOARD

(REFER TO STRUCTURAL / TRUSS SUPPLIER FOR DETAILS)

- 1/2" FIBER ROOF BOARD - LOW SLOPED RIGID INSULATION (SLOPED TO DRAIN)

- 5/8" TYPE X GYPSUM CEILING BOARD - 5/8" TYPE X GYPSUM CEILING BOARD (REFER TO STRUCTURAL / TRUSS SUPPLIER FOR DETAILS)

ROOF SCHEDULE NOTES

S1. 1 HOUR FIRE RATE ATTIC HATCHES: 2 LAYERS 5/8" TYPE X GYPSUM WALLBOARD

S2. PROVIDE 4-2x10 PLANK WALK-WAY IN ATTIC, MOUNTED ABOVE INSULATION CONTINUOUS FROM ATTIC ACCESS TO ATTIC

EXTEND 24" VERTICALLY MINIMUM ON ALL SURFACES VALLEYS AND JUNCTIONS WITH WALLS ABOVE ROOF

AND DRAIN LOCATIONS

RS3. ALL ROOFING AND RELATED WORK TO COMPLY WITH ROOFING CONTRACTORS ASSOCIATION'S

RS6. ALL BATT INSULATION TO BE FULL DEPTH OF WALL CAVITY AND

AND/OR PENETRATIONS.

SLOPE OF RIGID INSULATION / TRUSSES TO ROOF DRAINS / DOWNSPOUTS

architects inc.

9834-105 Street Edmonton, AB T5K 1A6 Office: (780) 423-3424 Seal

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BUILT STRONG

Issued:

Project No. Version: EG1188


Date 02/15/2023

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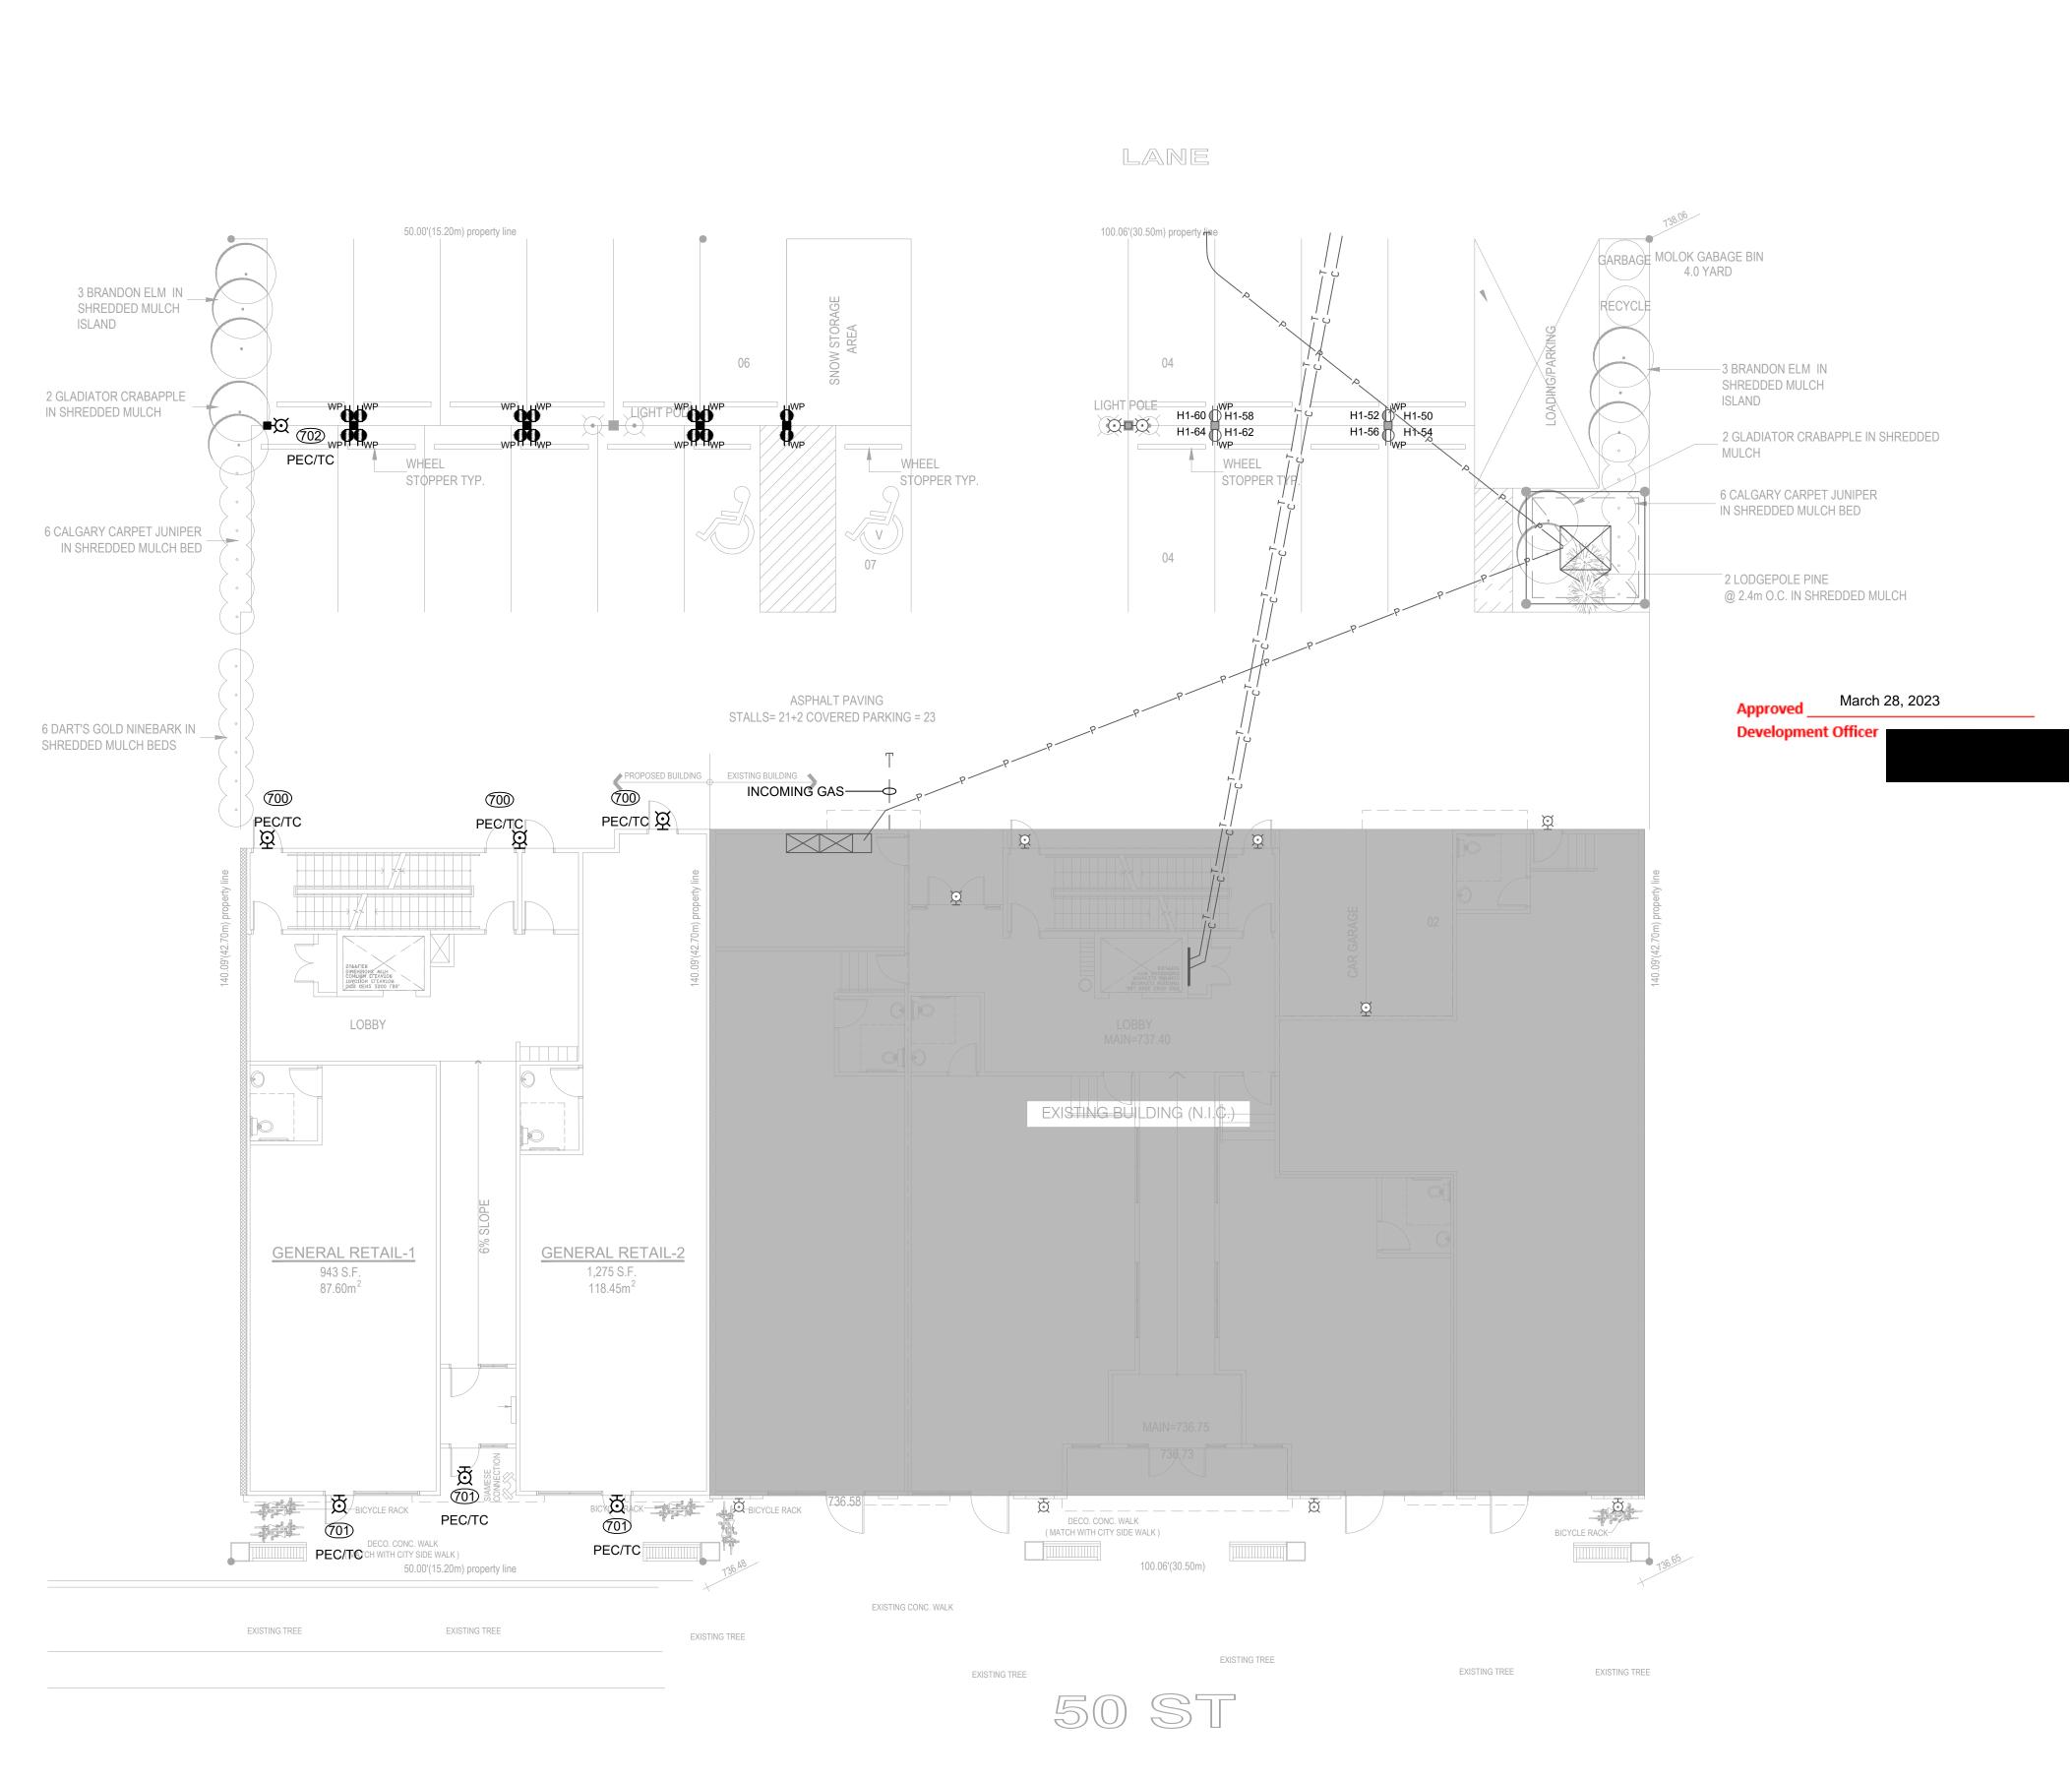
OVERALL ROOF PLAN

Drawing No.

A3.0

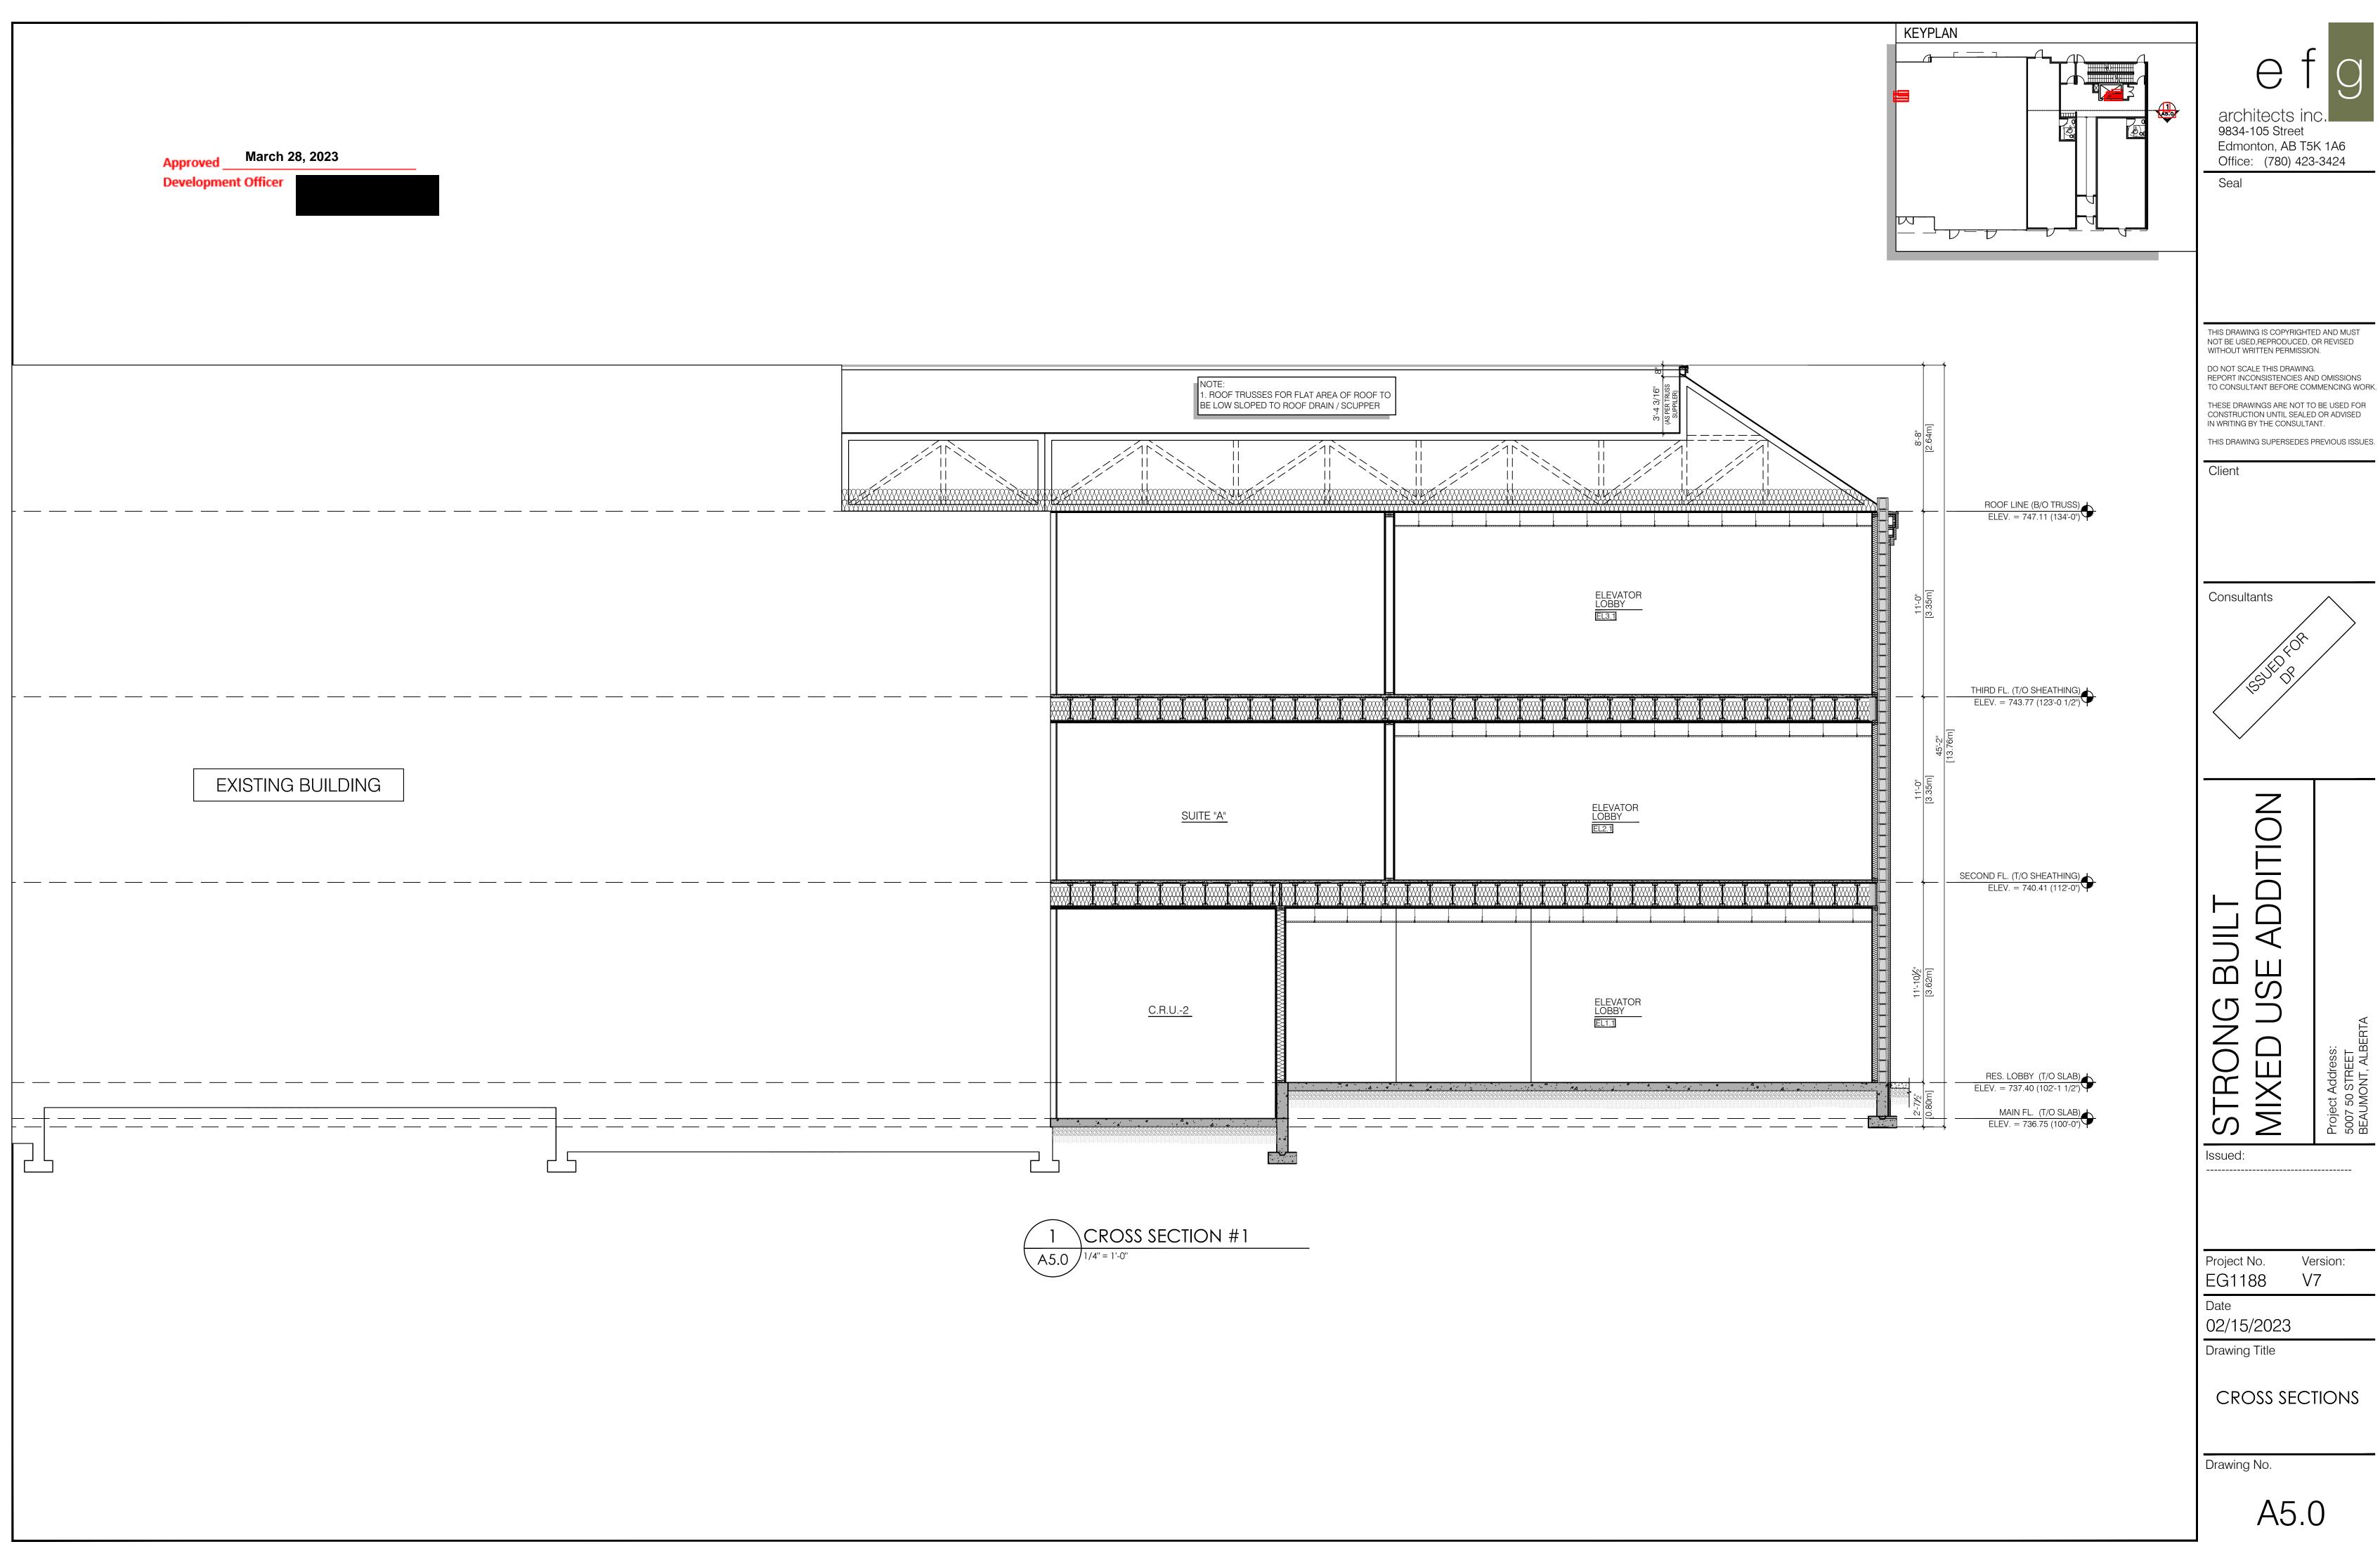

THIS DRAWING SUPERSEDES PREVIOUS ISSUES.





CEILING OR WALL MTD. LUMINAIRE CEILING OR WALL RECESSED LUMINAIRE STRIP LIGHT LUMINAIRE architects inc. CEILING SURFACE/SUSPENDED LUMINAIRE WALL MOUNTED LUMINAIRE 9834-105 Street RECESSED LUMINAIRE Edmonton, AB T5K 1A6 TRACK LIGHTING (HEADS AS SHOWN) Office: (780) 423-3424 SITE LIGHT LUMINAIRE (HEADS AS SHOWN) DENOTES LUMINAIRE TYPE (101) Seal **SWITCHES** S1 ← LOW VOLTAGE SWITCH(ES) SINGLE POLE SWITCH, SINGLE GANGED SINGLE POLE SWITCH, MULTI-GANGED 3=THREE WAY SWITCH/ 4=FOUR WAY SWITCH T=TIMER SWITCH/ K=KEY SWITCH SWITCH C/W NEON PILOT LIGHT DIMMER SWITCH VARIABLE SPEED SWITCH PERMIT TO PRACTICE TWS ENGINEERING LTD. OCCUPANCY SWITCH 0C↔ OCCUPANCY SENSOR WALL OCCUPANCY SENSOR PERMIT NUMBER: P 2276 **AUXILIARY** The Association of Professional Engineers Geologists and Geophysicists of Alberta MAGNETIC STARTER M MOTOR THIS DRAWING IS COPYRIGHTED AND MUST DISCONNECT NOT BE USED, REPRODUCED, OR REVISED MOTOR WITH DISCONNECT WITHOUT WRITTEN PERMISSION. • • • UP / STOP / DOWN DO NOT SCALE THIS DRAWING. LOW VOLTAGE REPORT INCONSISTENCIES AND OMISSIONS 'TO CONSULTANT BEFORE COMMENCING WORK. TELEPHONE OUTLET / ABOVE COUNTERTOP TELEVISION OUTLET / ABOVE COUNTERTOP THESE DRAWINGS ARE NOT TO BE USED FOR CONSTRUCTION UNTIL SEALED OR ADVISED ▶ • DATA OUTLET/ ABOVE COUNTERTOP IN WRITING BY THE CONSULTANT. ▶ • COMBO TELE/DATA OUTLET/ ABOVE COUNTER THIS DRAWING SUPERSEDES PREVIOUS ISSUES. **D** SPEAKER ALARM MICROPHONE Client CEILING SPEAKER / WALL SPEAKER POWER / RECEPTACLE DUPLEX RECEPTACLE DUPLEX T-SLOT RECEPTACLE/ 20AMP GFI T-SLOT RECEPTACLE/ 20AMP SPLIT RECEPTACLE WP→ EXP→ WP=WEATHERPROOF/EXP=EXPLOSION PROOF 4-PLEX RECEPTACLE GFI RECEPTACLE Consultants 1/2 SWITCHED RECEPTACLE ISOLATED GROUND DEVICE MOUNT 6"(150mm) ABOVE COUNTERTOP CONDU-POLE (POWER & COMMUNICATIONS) SPECIAL RECEPTACLE Engineering Ltd. SPLIT CAR POST P**=** 9918 - 75 AVENUE Phone: (780) 468-5477 EDMONTON, AB. T6E 1J2 Fax: (780) 465-5368 VP**=** CAR POST VP_____WP SPLIT DOUBLE CAR POST office@twsengineering.com www.twsengineering.com WP_____WP DOUBLE CAR POST **EMERGENCY** CEILING OR WALL MOUNTED EXIT LIGHT WALL MOUNTED EXIT LIGHT C/W EM HEADS BATTERY PACK / BATTERY PACK C/W HEADS Ē REMOTE EMERGENCY HEADS FIRE ALARM FIRE ALARM PULL STATION FIRE ALARM HORN C/W STROBE (CEILING/WALL) FIRE ALARM STROBE (CEILING/WALL) BUIL FIRE ALARM HORN (NO STROBE) MINI HORN (NO STROBE) C/W PUSHBUTTON SILENCER SPEAKER STROBE OR MINI HORN STROBE WITH SILENCER MODULE & PUSHBUTTON BELOW SILENCER MODULE C/W PUSHBUTTON SILENCER MODULE/ REMOTE PUSHBUTTON MAGNETIC DOOR HOLDER BUILDING LOCATION Œ ALARM BELL MIXE FIRE ALARM SPEAKER FIRE ALARM SPEAKER/STROBE (CEILING/WALL) FIRE PHONE ● ● SMOKE DETECTOR / C=SMOKE CO COMBO **⊕**^D **●**^A D=DUCT DETECTOR/ A=SMOKE ALARM I=ISOLATION MODULE/ MM=MONITOR MODULE Issued: CONTROL RELAY . 2022-DEC-13 ISSUED FOR REVIEW 2. 2023-MAR-20 ISSUED FOR DP D D M=MOTION SENSOR / C=CAMERA PUSHBUTTON © MI C=DOOR CONTACT/ MAGNETIC DOOR LOCK BUZZER WITH TRANSFORMER NUMERIC KEYPAD FOB ES FOB READER / ES = ELECTRIC STRIKE Project No. → EMERGENCY CALL 22-2534-002 DISTRIBUTION / MISCELLANEOUS MAIN DISTRIBUTION PANEL Date SINGLE OR DOUBLE ELECTRICAL PANEL 10/17/2022 TELEPHONE BACKBOARD METER CENTER Drawing Title INSIDE TRANSFORMER (kVA AS SHOWN) SITE PLAN TRANSFORMER WITH RAILS CONDUIT RUN IN WALLS OR CEILING — CONDUIT RUN IN OR UNDER FLOOR MDP MAIN DISTRIBUTION PANEL CDP SUB-DISTRIBUTION PANEL PEC PHOTO ELECTRIC CELL FAAP FIRE ALARM ANNUCIATOR PANEL FACP FIRE ALARM CONTROL PANEL Drawing No.

SYMBOL LEGEND

LIGHTING

NIGHT LIGHT

TVTC | TELEVISION TERMINAL CABINET TTC | TELEPHONE TERMINAL CABINET TVTB TELEVISION TERMINAL BACKBOARD TTB TELEPHONE TERMINAL BACKBOARD

E401 SINGLE LINE DIAGRAM E402 FIRE ALARM RISER E403 COMMUNICATION RISER

E601 ELECTRICAL FIRE STOPPING

CIVIC ADDRESS:

5007 50 STREET

E001 SITE PLAN

E203

BEAUMONT , ALBERTA

DRAWING LIST

	RENOVATION LEGEND	
	∳∳or∳∳ RM	EXISTING TO BE REMOVED FADED/DASHED DEVICE WITH OR WITHOUT "RM" INDICATES DEVICE TO BE REMOVED AND DISPOSED OF AT THE DIRECTION OF THE OWNERS REPRESENTATIVE
	₩ RL	EXISTING TO BE RELOCATED FADED/DASHED DEVICE WITH "RL" OR ARROW INDICATE DEVICE TO BE RELOCATED TO A NEW LOCATION
	⊗or⊗ E	EXISTING TO REMAIN FADED/SOLID DEVICE WITH OR WITHOUT "E" INDICATES EXISTING DEVICE TO REMAIN
	⊕ RP	EXISTING TO BE REPLACED SOLID DEVICE WITH "RP" INDICATES EXISTING DEVICE TO BE REPLACED AT THE SAME LOCATION WITH NEW DEVICE.
	8	NEW DEVICE SOLID DEVICE INDICATES NEW DEVICE

LANE 50.00'(15.20m) property line 0.7 0.7 0.8 0.8 0.7 0.7 0.8 0.8 0.8 0.8 0.93 BRANDON ELM IN SHREDDED MULCH $\sqrt[4]{0.7}$ $\sqrt[4]{0.8}$ $\sqrt[4]$ ISLAND -3 BRANDON ELM IN **5.**0 1.2 1.3 1.4 1.3 1.3 1.2 1.3 1.8 SHREDDED MULCH 2 GLADIATOR CRABAPPLE ISLAND IN SHREDDED MULCH 2 GLADIATOR CRABAPPLE IN SHREDDED MULCH $\begin{bmatrix} 0.7 & 0.7 & 0.8 & 0.$ 1.2 | 1.0 | 0.86 CALGARY CARPET JUNIPER IN SHREDDED MULCH BED 6 CALGARY CARPET JUNIPER 2 LODGEPOLE PINE @ 2.4m O.C. IN SHREDDED MULCH $\begin{bmatrix} 0.8 & 0.8 & 0.9 & 0.9 & 0.9 & 0.9 & 1.0 & 1.0 & 1.0 & 1.0 & 1.1 & 1.2 & 1.3 & 1.4 & 1.5 & 1.4 & 1.4 & 1.4 & 1.3 & 1.1 & 1.1 & 1.1 & 1.2 & 1.3 & 1.4 & 1.5 & 1.4 & 1.$ 10.9 10.9 10.9 10.1 10.2 10.3 10.3 10.2 10.1 10.2 10.4 10.5 10.5 10.5 10.5 10.5 10.51.6 1.4 1.1 1.3 1.8 2.1 2.3 2.5 1.5 5 ALLS 1.2 COVERED PARTING = 23 1.8 2.3 2.2 1.9 1.7 1.7 1.9 1.4 1.1 1.2 1.9 2.0 1.26 DART'S GOLD NINEBARK IN SHREDDED MULCH BEDS 3.1 2.3 1.4 1.8 3.2 3.7 3 9 ROPOSET BUILDING 3 EXISTING BUILDING 1.0 $\frac{1}{4}.3$ $\frac{1}{3}.3$ $\frac{1}{2}.1$ $\frac{1}{2}.2$
 3.3
 1.8
 0.9
 1.7
 3.6
 4.0
 1.9
 $3.3 \quad 1.3 \quad 0.9 \quad 5.9 \quad 3.7 \quad 2.9 \quad 5.5 \quad 2.3 \quad 2.3 \quad 75.8 \quad 0.8 \quad 0.9 \quad 1.0 \quad 1.4 \quad 4.5 \quad 5.5 \quad 1.$ 6.9 4.5 †.8 †.6 †.6 1.5 3.1 3.01.8 5.5 5.1 LOBBY EXISTING BUILDING (N.I.C.) **GENERAL RETAIL-1 GENERAL RETAIL-2** 943 S.F. 1,275 S.F. 87.60m² 118.45m²
 0.1
 0.4
 0.1
 0.1
 BICYGRACK 736.58 736.58 4.1 1000 8.8 9.3 8.2 7.7 10.3 11.9 13.1 9.4 3.2 0.5 2.5 1.8 4 DECO. CONG. WALK 0.7 3.3 9.4 10.3 3.8 0.4 2.2 BLOCAL BRACK 12.5 50.00'(15.20m) property line $\frac{1}{2.4}$ $\frac{1}{4.6}$ $\frac{1}{4.3}$ $\frac{1}{3.7}$ $\frac{1}{2.9}$ $\frac{1}{3.2}$ $\frac{1}{5.1}$ $\frac{1}{6.1}$ $\frac{1}{5.6}$ $\frac{1}{4.5}$ $\frac{1}{2.0}$ $\frac{1}{0.5}$ $\frac{1}{1.0}$ $\frac{1}{3.9}$ $\frac{1}{5.0}$ $\frac{1}{2.8}$ $\frac{1}{0.5}$ $\frac{1}{2.1}$ $\frac{1}{4.4}$ $\frac{1}{4.7}$ $\frac{1}{2.3}$ $\frac{1}{0.4}$ $\frac{1}{0.5}$ $\frac{1}{3.5}$ $\frac{1}{5.1}$ 50 ST

March 28, 2023 Development Officer

WALL MOUNTED LUMINAIRE RECESSED LUMINAIRE TRACK LIGHTING (HEADS AS SHOWN) SITE LIGHT LUMINAIRE (HEADS AS SHOWN) DENOTES LUMINAIRE TYPE (101) SWITCHES LOW VOLTAGE SWITCH(ES) SINGLE POLE SWITCH, SINGLE GANGED SINGLE POLE SWITCH, MULTI-GANGED 3=THREE WAY SWITCH/ 4=FOUR WAY SWITCH T=TIMER SWITCH/ K=KEY SWITCH τω κω SWITCH C/W NEON PILOT LIGHT DIMMER SWITCH VARIABLE SPEED SWITCH OCCUPANCY SWITCH 0C↔ OCCUPANCY SENSOR WALL OCCUPANCY SENSOR **AUXILIARY** MAGNETIC STARTER $\bigcirc \bigcirc \bigcirc$ J=JUNCTION BOX/ T=THERMOSTAT/ H=HUMIDISTAT MOTOR W DISCONNECT MOTOR WITH DISCONNECT UP / STOP / DOWN LOW VOLTAGE TELEPHONE OUTLET / ABOVE COUNTERTOP → → TELEVISION OUTLET / ABOVE COUNTERTOP DATA OUTLET/ ABOVE COUNTERTOP ► • COMBO TELE/DATA OUTLET/ ABOVE COUNTER SPEAKER ALARM MICROPHONE Client CEILING SPEAKER / WALL SPEAKER POWER / RECEPTACLE DUPLEX RECEPTACLE DUPLEX T-SLOT RECEPTACLE/ 20AMP GFI T-SLOT RECEPTACLE/ 20AMP SPLIT RECEPTACLE WP→ EXP→ WP=WEATHERPROOF/EXP=EXPLOSION PROOF 4-PLEX RECEPTACLE GFI RECEPTACLE 1/2 SWITCHED RECEPTACLE ISOLATED GROUND DEVICE MOUNT 6"(150mm) ABOVE COUNTERTOP CONDU-POLE (POWER & COMMUNICATIONS) SPECIAL RECEPTACLE SPLIT CAR POST /P WP= CAR POST WP-COMPONIE CAR POST WP DOUBLE CAR POST **EMERGENCY** CEILING OR WALL MOUNTED EXIT LIGHT WALL MOUNTED EXIT LIGHT C/W EM HEADS BATTERY PACK / BATTERY PACK C/W HEADS REMOTE EMERGENCY HEADS FIRE ALARM FIRE ALARM PULL STATION FIRE ALARM HORN C/W STROBE (CEILING/WALL) FIRE ALARM STROBE (CEILING/WALL) FIRE ALARM HORN (NO STROBE) MINI HORN (NO STROBE) C/W PUSHBUTTON SILENCER SPEAKER STROBE OR MINI HORN STROBE WITH SILENCER MODULE & PUSHBUTTON BELOW SILENCER MODULE C/W PUSHBUTTON SILENCER MODULE/ REMOTE PUSHBUTTON MAGNETIC DOOR HOLDER BUILDING LOCATION Œ ALARM BELL FIRE ALARM SPEAKER FIRE ALARM SPEAKER/STROBE (CEILING/WALL) FIRE PHONE SMOKE DETECTOR / C=SMOKE CO COMBO ● D=DUCT DETECTOR/ A=SMOKE ALARM Issued: © CONTROL RELAY . 22-DEC-13 ISSUED FOR REVIEW 2. March 17, 2023 ISSUED FOR DP D D M=MOTION SENSOR / C=CAMERA PUSHBUTTON © ML C=DOOR CONTACT/ MAGNETIC DOOR LOCK BUZZER WITH TRANSFORMER NUMERIC KEYPAD FOB ES FOB READER / ES = ELECTRIC STRIKE Project No. → EMERGENCY CALL 22-2534-002 DISTRIBUTION / MISCELLANEOUS MAIN DISTRIBUTION PANEL Date SINGLE OR DOUBLE ELECTRICAL PANEL 10/17/2022 TELEPHONE BACKBOARD

SYMBOL LEGEND

LIGHTING

CEILING OR WALL RECESSED LUMINAIRE

CEILING SURFACE/SUSPENDED LUMINAIRE

CEILING OR WALL MTD. LUMINAIRE

STRIP LIGHT LUMINAIRE

architects inc.

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Seal

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Consultants

Engineering Ltd.

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METER CENTER

RENOVATION LEGEND FADED/DASHED DEVICE WITH OR WITHOUT "RM" INDICATES DEVICE TO BE REMOVED AND DISPOSED OF AT THE DIRECTION OF THE OWNERS REPRESENTATIVE FADED/DASHED DEVICE WITH "RL" OR ARROW INDICATES MDP DEVICE TO BE RELOCATED TO A NEW LOCATION FADED/SOLID DEVICE WITH OR WITHOUT "E" INDICATES SOLID DEVICE WITH "RP" INDICATES EXISTING DEVICE TO TVTC TELEVISION TERMINAL CABINET BE REPLACED AT THE SAME LOCATION WITH NEW DEVICE TTC TELEPHONE TERMINAL CABINET TVTB TELEVISION TERMINAL BACKBOARD

CIVIC ADDRESS:

5007 50 STREET

E401 SINGLE LINE DIAGRAM

E403 COMMUNICATION RISER

E601 ELECTRICAL FIRE STOPPING

E402 FIRE ALARM RISER

E001 SITE PLAN

E203

EXISTING TO BE REMOVED

EXISTING TO BE RELOCATED

EXISTING DEVICE TO REMAIN

EXISTING TO BE REPLACED

SOLID DEVICE INDICATES NEW DEVICE

EXISTING TO REMAIN

BEAUMONT, ALBERTA

DRAWING LIST

INSIDE TRANSFORMER (kVA AS SHOWN) TRANSFORMER WITH RAILS CONDUIT RUN IN WALLS OR CEILING CONDUIT RUN IN OR UNDER FLOOR MAIN DISTRIBUTION PANEL SUB-DISTRIBUTION PANEL PHOTO ELECTRIC CELL FAAP FIRE ALARM ANNUCIATOR PANEL FACP FIRE ALARM CONTROL PANEL NIGHT LIGHT

TTB TELEPHONE TERMINAL BACKBOARD

Drawing Title SITE PLAN

Drawing No.